


EXHIBIT A

"REVISED"

Working as agent for DBPR

These Prints comply with the
Florida Manufactured Bld.
Act and adopted Codes and
Standards.

Adhere to the following Criteria

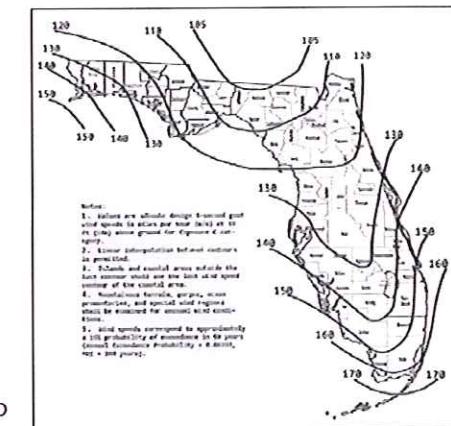ITEMS BY OTHERS:
Construction Type V-B THE FOLLOWING ITEMS MAY BE SUPPLIED AND
Occupancy U INSTALLED BY OTHERS. THESE ITEMS MAY BE
Allowable 1 SUBJECT TO LOCAL JURISDICTION APPROVAL.
Wind Velocity 160 MPH WEATHER KING PORTABLE BUILDINGS IS NOT
RESPONSIBLE FOR THESE ITEMS.Fire Rating of Ext Wall NA 1. THE FOUNDATION AND TIE-DOWN SYSTEM
Plan No IRPER210076Allow. Floor Load 40 2. RAMPS, STAIRS, AND GENERAL ACCESSApproval Date 3/27/23 3. ELECTRICAL SERVICE HOOKUPManf Weather KingApproved by Phillip E Robbins Florida PE-49070From the requirements of applicable Phillip E Robbins State LawsPlan No IRPER210076 Date 03/27/2023Approved by Phillip E Robbins Florida PE-49070From the requirements of applicable Phillip E Robbins State LawsPlan No IRPER210076 Date 03/27/2023

GENERAL NOTES:

- STRUCTURE HAS BEEN DESIGNED IN ACCORDANCE WITH THE 2020 FLORIDA BUILDING CODE (FBC).
- ALL MATERIALS AND CONSTRUCTION SHALL BE IN ACCORDANCE WITH THE ABOVE CODES AT THE TIME OF MANUFACTURE.
- DRAWINGS SHALL NOT BE SCALED FOR DIMENSIONS.
- STRUCTURES ARE CLASSIFIED AS "MINOR STORAGE FACILITIES" (RISK CATEGORY I) PER TABLE 1604.5 AND SHOULD NOT BE USED FOR HUMAN HABITATION.
- STRUCTURES ARE DESIGNED FOR LOCATIONS THAT HAVE A 3 SECOND WIND GUST OF 160 MPH FOR RISK CATEGORY I STRUCTURES PER FIGURE 1609.3(4) OF THE 2020 FBC.
- SIDING FASTENERS SHALL NOT BE INSTALLED IN PANEL SIDING GROOVES IN THE FIELD OF THE PANEL OR WHEN THE SIDING GROOVES OCCUR AT CUT EDGES OF THE SIDING PANEL.
- STRUCTURES ARE DESIGNED FOR LOCATIONS THAT ARE NOT IN FLOOD HAZARD AREAS.
- IN ACCORDANCE WITH FBC 1609.1.2, STORAGE SHEDS NOT DESIGNED FOR HUMAN HABITATION WITH A FLOOR AREA OF 720 SQUARE FEET OR LESS ARE NOT REQUIRED TO COMPLY WITH THE MANDATORY WINDBORNE DEBRIS IMPACT STANDARDS OF THE 2020 FBC.
- IN ACCORDANCE WITH FBC 1010.1.1, BUILDINGS THAT ARE 400 SQUARE FEET OR LESS THAT ARE INTENDED FOR USE IN CONJUNCTION WITH ONE- AND TWO- FAMILY RESIDENCES ARE NOT SUBJECT TO THE DOOR HEIGHT AND WIDTH REQUIREMENTS OF THE 2020 FBC.
- ALL ROOF DECKING IS TO BE $\frac{7}{16}$ " OSB, $\frac{15}{32}$ " PLYWOOD, $\frac{1}{2}$ " PLYWOOD, OR EQUIVALENT. FASTEN ROOF SHEATHING TO ROOF FRAMING WITH $2\frac{3}{8}$ " RING SHANK NAILS SPACED AT 6" MAX, UNLESS NOTED OTHERWISE ON SHEET S-1.6.
- ALL SIDING IS TO BE TREATED T1-11, LP SMARTSIDE PANEL, OR 29 GA. METAL SIDING.

- ALL FLOOR JOISTS ARE TO BE PRESSURE TREATED SYP #2, OR BETTER.
- ALL UN-TREATED WOOD FRAMING IS TO BE TO BE SPF #2 OR BETTER, UNLESS NOTED OTHERWISE.
- WOOD FRAMING SHALL COMPLY WITH THE ANSI/AWC "NATIONAL DESIGN SPECIFICATION (NDS) FOR WOOD CONSTRUCTION", 2018.
- ALL FLOOR DECKING IS TO BE $\frac{5}{8}$ " TREATED PLYWOOD OR $\frac{5}{8}$ " PERFORMAX 500 FLOOR SHEATHING. FLOORING CLOSER THAN 18 INCHES TO EXPOSED GROUND SHALL BE OF NATURALLY DURABLE OR PRESERVATIVE-TREATED WOOD IN ACCORDANCE WITH 2304.12.1.1.
- ALL SKIDS ARE TO BE 4x6 PRESSURE TREATED, RATED FOR GROUND CONTACT.
- REFER TO THE SUPPLIED FASTENING SCHEDULE FOR FASTENING BASED ON CONNECTION AND LOCATION OF MEMBERS AS PER THE 2020 FLORIDA BUILDING CODE TABLE 2304.10.1, UNLESS NOTED OTHERWISE.
- ALL EXTERIOR NAILS ARE TO BE ZINC COATED.
- STRUCTURES SHOULD HAVE 30 YEAR RATED ASPHALT SHINGLES CONFORMING TO ASTM D3161 (CLASS F) OR ASTM D7158 (CLASS H) OR 29 GA METAL ROOF PANELS.
- SECTIONS AND DETAILS SHOWN ARE INTENDED TO BE TYPICAL AND SHALL APPLY AT ALL SIMILAR LOCATIONS, UNLESS NOTED OTHERWISE.
- ALL BUILDINGS ARE TO BE ADEQUATELY ANCHORED TO RESIST WIND LOADS. ANCHORING OF THE BUILDING IS SUBJECT TO LOCAL JURISDICTION APPROVAL.
- BUILDINGS HAVE NOT BEEN DESIGNED FOR HVHZ REQUIREMENTS AS SET FORTH IN THE 2020 FBC.

DESIGN CRITERIA:

1. RISK CATEGORY I

2. LIVE LOADS:

FLOOR: 40 PSF

LOFT: 10 PSF

ROOF: 20 PSF

3. DEAD LOADS:

FLOOR: 4 PSF

ROOF: 5 PSF

WALLS: 3 PSF

4. WIND LOADS ARE BASED ON

Vult = 160 MPH (2020)

Vasd = 124 MPH

RISK CATEGORY I

EXPOSURE CATEGORY C

INTERNAL PRESSURE COEFFICIENT:

GCpi = ±0.18

COMPONENTS & CLADDING:

EFFECTIVE WIND AREA, Ae = 10 FT²

ROOF-ZONE 1 = 19.3, -30.6 PSF

ROOF-ZONE 2 = 19.3, -53.3 PSF

ROOF-ZONE 3 = 19.3, -78.9 PSF

WALL-ZONE 4 = 33.5, -36.3 PSF

WALL-ZONE 5 = 33.5, -44.8 PSF

EFFECTIVE WIND AREA, Ae = 20 FT²

ROOF-ZONE 1 = 17.6, -29.8 PSF

ROOF-ZONE 2 = 17.6, -49.0 PSF

ROOF-ZONE 3 = 17.6, -73.7 PSF

WALL-ZONE 4 = 32.0, -34.8 PSF

WALL-ZONE 5 = 32.0, -41.8 PSF

NOTE: C&C WIND PRESSURES SHOWN MAY BE REDUCED FOR LARGER AREAS AS ALLOWED BY CODE.

5. CONSTRUCTION TYPE: V-B

6. OCCUPANCY GROUP U

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WEATHER KING
P.O. BOX 108
PARIS, TN 38242



LOFTED BARN--FLORIDA--WIND=160 MPH--FBC 2020

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Weather King
PORTABLE BUILDINGS

PROJECT NO: 09-28-2021
DATE: 09-28-2021
DRAWN BY: KLN
CHECKED BY: KLN
REVISION: 03-22-2023

SHEET NUMBER
S-0-LB
SCALE: NONE


Approved by Phillip E Robbins
Florida PE-49070
Phillip E Robbins
Plan No. 1RPER210076 Date: 03/27/2023

FASTENING SCHEDULE

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DESCRIPTION OF BUILDING ELEMENT	NUMBER AND TYPE OF FASTENER	SPACING AND LOCATION
ROOF FRAMING		
1. BLOCKING BETWEEN CEILING JOISTS OR RAFTERS TO TOP PLATE OR OTHER FRAMING.	3 - 8d COMMON (2 $\frac{1}{2}$ " x 0.131") 3 - 10d BOX (3" x 0.128") 3 - 3" x 0.131" NAILS 3 - 3" 14 GAGE STAPLES, $\frac{1}{16}$ " CROWN	EACH END, TOENAIL
2. BLOCKING BETWEEN RAFTERS NOT AT THE WALL TOP PLATE, TO RAFTER.	2 - 8d COMMON (2 $\frac{1}{2}$ " x 0.131") 2 - 3" x 0.131" NAILS 2 - 3" 14 GAGE STAPLES 2 - 16d COMMON (3 $\frac{1}{2}$ " x 0.162") 3 - 3" x 0.131" NAILS 3 - 3" 14 GAGE STAPLES	EACH END, TOENAIL END NAIL
COLLAR TIE TO RAFTER	REFERENCE SHEETS S-2.4 AND S-2.5	
RAFTER OR ROOF TRUSS TO TOP PLATE	3 - 10d COMMON (3" x 0.148") 3 - 16d BOX (3 $\frac{1}{2}$ " x 0.135") 4 - 10d BOX (3" x 0.128") 4 - 3" x 0.131" NAILS 4 - 3" 14 GAGE STAPLES, $\frac{1}{16}$ " CROWN	TOENAIL ^b
CEILING JOISTS TO TOP PLATE	3 - 8d COMMON (2 $\frac{1}{2}$ " x 0.131") 3 - 10d BOX (3" x 0.128") 3 - 3" x 0.131" NAILS 3 - 3" 14 GAGE STAPLES, $\frac{1}{16}$ " CROWN	EACH JOIST, TOENAIL
WALL FRAMING		
STUD TO STUD (NOT AT BRACED WALL PANELS)	16d COMMON (3 $\frac{1}{2}$ " x 0.162")	24" O.C. FACE NAIL
	10d BOX (3" x 0.128") 3" x 0.131" NAILS 3 - 3" 14 GAGE STAPLES	16" O.C. FACE NAIL
STUD TO STUD AND ABUTTING STUDS AT INTERSECTING WALL CORNERS (AT BRACED WALL PANELS)	16d COMMON (3 $\frac{1}{2}$ " x 0.162")	16" O.C. FACE NAIL
	16d BOX (3 $\frac{1}{2}$ " x 0.135")	12" O.C. FACE NAIL
	3" x 0.131" NAILS 3 - 3" 14 GAGE STAPLES, $\frac{1}{16}$ " CROWN	12" O.C. FACE NAIL
CONTINUOUS HEADER TO STUD	4 - 8d COMMON (2 $\frac{1}{2}$ " x 0.131") 4 - 10d BOX (3" x 0.128")	TOENAIL
TOP PLATE TO TOP PLATE	16d COMMON (3 $\frac{1}{2}$ " x 0.162")	16" O.C. FACE NAIL
	10d BOX (3" x 0.128") 3" x 0.131" NAILS 3" 14 GAGE STAPLES, $\frac{1}{16}$ " CROWN	12" O.C. FACE NAIL

DESCRIPTION OF BUILDING ELEMENT	NUMBER AND TYPE OF FASTENER	SPACING AND LOCATION
WALL FRAMING (CONT.)		
TOP PLATE TO TOP PLATE, AT END JOINTS	8 - 16d COMMON (3 $\frac{1}{2}$ " x 0.162") 12 - 10d BOX (3" x 0.128") 12 - 3" x 0.131" NAILS 12 - 3" 14 GAGE STAPLES, $\frac{1}{16}$ " CROWN	EACH SIDE OF END JOINT, FACE NAIL (MINIMUM 24" LAP SPLICE LENGTH EACH SIDE OF END JOINT)
BOTTOM PLATE TO JOIST, RIM JOIST, BAND JOIST, OR BLOCKING (NOT AT BRACED WALL PANELS)	16d COMMON (3 $\frac{1}{2}$ " x 0.162") 16d BOX (3 $\frac{1}{2}$ " x 0.135") 3" x 0.131" NAILS 3" 14 GAGE STAPLES, $\frac{1}{16}$ " CROWN	16" O.C. FACE NAIL
BOTTOM PLATE TO JOIST, RIM JOIST, BAND JOIST, OR BLOCKING (AT BRACED WALL PANELS)	2 - 16d COMMON (3 $\frac{1}{2}$ " x 0.162") 3 - 16d BOX (3 $\frac{1}{2}$ " x 0.135") 4 - 3" x 0.131" NAILS 4 - 3" 14 GAGE STAPLES, $\frac{1}{16}$ " CROWN	16" O.C. FACE NAIL
STUD TO TOP OR BOTTOM PLATE	4 - 8d COMMON (2 $\frac{1}{2}$ " x 0.131") 4 - 10d BOX (3" x 0.128") 4 - 3" x 0.131" NAILS 4 - 3" 14 GAGE STAPLES, $\frac{1}{16}$ " CROWN	TOENAIL
	2 - 16d COMMON (3 $\frac{1}{2}$ " x 0.162") 3 - 10d BOX (3" x 0.128") 3 - 3" x 0.131" NAILS 3 - 3" 14 GAGE STAPLES, $\frac{1}{16}$ " CROWN	END NAIL
TOP PLATES, LAPS AT CORNERS AND INTERSECTIONS	2 - 16d COMMON (3 $\frac{1}{2}$ " x 0.162") 3 - 10d BOX (3" x 0.128") 3 - 3" x 0.131" NAILS 3 - 3" 14 GAGE STAPLES, $\frac{1}{16}$ " CROWN	FACE NAIL
FLOOR FRAMING		
JOIST TO SKID	3 - 8d COMMON (2 $\frac{1}{2}$ " x 0.131") 3 - 10d BOX (3" x 0.128") 3 - 3" x 0.131" NAILS 3 - 3" 14 GAGE STAPLES, $\frac{1}{16}$ " CROWN	TOENAIL
BUILT-UP BEAMS	10d BOX (3" x 0.128") 3" x 0.131" NAILS 3" 14 GAGE STAPLES, $\frac{1}{16}$ " CROWN	24" O.C. FACE NAIL AT TOP AND BOTTOM STAGGERED ON OPPOSITE SIDES
	AND: 3 - 10d BOX (3" x 0.128") 3 - 3" x 0.131" NAILS 3 - 3" 14 GAGE STAPLES, $\frac{1}{16}$ " CROWN	ENDS AND AT EACH SPLICE, FACE NAIL
JOIST TO BAND JOIST OR RIM JOIST	3 - 16d COMMON (3 $\frac{1}{2}$ " x 0.162") 4 - 10d BOX (3" x 0.128") 4 - 3" x 0.131" NAILS 4 - 3" 14 GAGE STAPLES, $\frac{1}{16}$ " CROWN	END NAIL

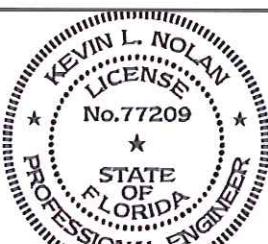

LOFTED BARN--FLORIDA--WIND=160 MPH--FBC 2020

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PORTABLE BUILDINGS

PROJECT NO:

DATE: 09-28-2021

DRAWN BY: KLN

CHECKED BY: KLN

REVISION:

SHEET NUMBER

S-01-LB

SCALE: NONE

FASTENING SCHEDULE (CONT.)

DESCRIPTION OF BUILDING ELEMENT	NUMBER AND TYPE OF FASTENER	SPACING AND LOCATION	
SUBFLOOR, ROOF AND INTERIOR WALL SHEATHING ^a			
		EDGES (INCHES)	INTERMEDIATE SUPPORTS (INCHES)
$\frac{1}{2}''$ TO $\frac{3}{4}''$	6d COMMON OR DEFORMED (2" x 0.113") (SUBFLOOR AND WALL)	6	12
	8d COMMON OR DEFORMED (2 $\frac{1}{2}$ " x 0.131") (ROOF)	6	12
	2 $\frac{1}{2}$ " x 0.113" NAIL (SUBFLOOR AND WALL)	6	12
	1 $\frac{1}{4}$ " 16 GAGE STAPLE, $\frac{1}{8}$ " CROWN (SUBFLOOR AND WALL)	4	8
	2 $\frac{1}{2}$ " x 0.113" RING SHANK NAIL (ROOF)	6	12
	1 $\frac{1}{4}$ " 16 GAGE STAPLE, $\frac{1}{8}$ " CROWN (ROOF)	3	6
$\frac{3}{4}''$ TO $\frac{5}{8}''$	8d COMMON (2 $\frac{1}{2}$ " x 0.131") 6d DEFORMED (2" x 0.113") (SUBFLOOR AND WALL)	6	12
	2 $\frac{1}{2}$ " x 0.113" RING SHANK NAIL	6	12
EXTERIOR WALL SIDING			
$\frac{3}{4}''$ LP SMARTSIDE PRECISION PANEL OR $\frac{3}{4}''$ TREATED T1-11 SIDING	2 $\frac{1}{2}$ " x 0.113" RING SHANK NAIL	6 (SIDE WALL)	6
	2 $\frac{1}{2}$ " x 0.113" RING SHANK NAIL	3 (END WALL)	6

a. NAILS SPACED AT 6 INCHES AT INTERMEDIATE SUPPORTS WHERE SPANS ARE 48 INCHES OR MORE. NAILS FOR WALL SHEATHING ARE PERMITTED TO BE COMMON, BOX, OR CASING.
 b. WHERE A RAFTER IS FASTENED TO AN ADJACENT PARALLEL CEILING JOIST IN ACCORDANCE WITH THIS SCHEDULE AND THE CEILING JOIST IS FASTENED TO THE TOP PLATE IN ACCORDANCE WITH THIS SCHEDULE, THE NUMBER OF TOENAILS IN THE RAFTER SHALL BE PERMITTED TO BE REDUCED BY ONE NAIL.

Approved by Phillip E Robbins
 Florida PE-49070
 Phillip E Robbins
 Plan No. 1RPER210076 Date: 03/27/2023

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LOFTED BARN--FLORIDA--WIND=160 MPH--FBC 2020

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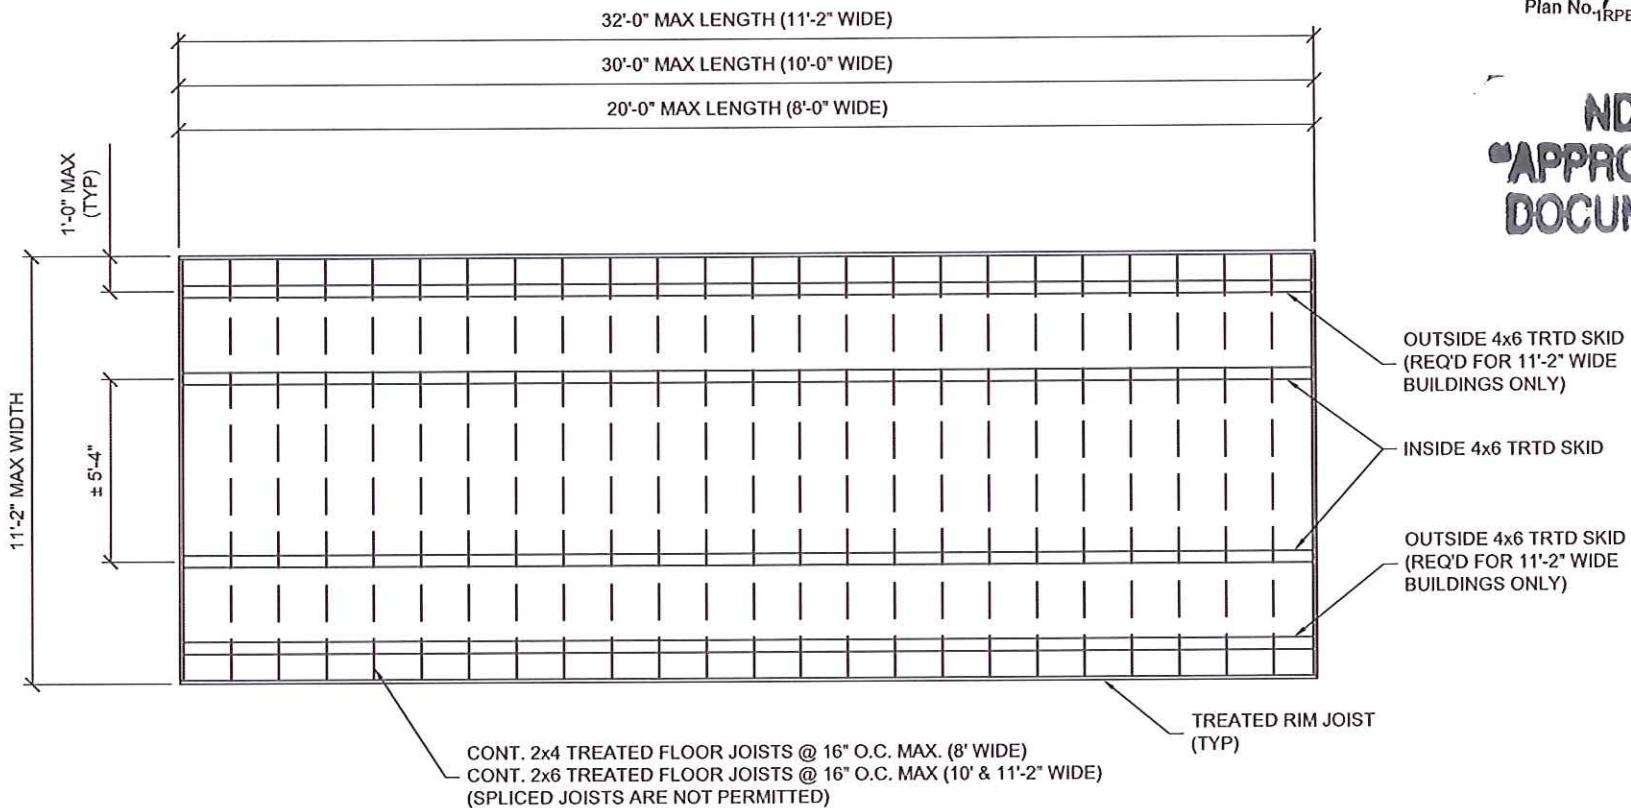
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 PORTABLE BUILDINGS

PROJECT NO:
 DATE: 09-28-2021
 DRAWN BY: KLN
 CHECKED BY: KLN
 REVISION:

SHEET NUMBER
S-02-LB
 SCALE: NONE

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Phillip E Robbins
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TYPICAL FLOOR FRAMING PLAN



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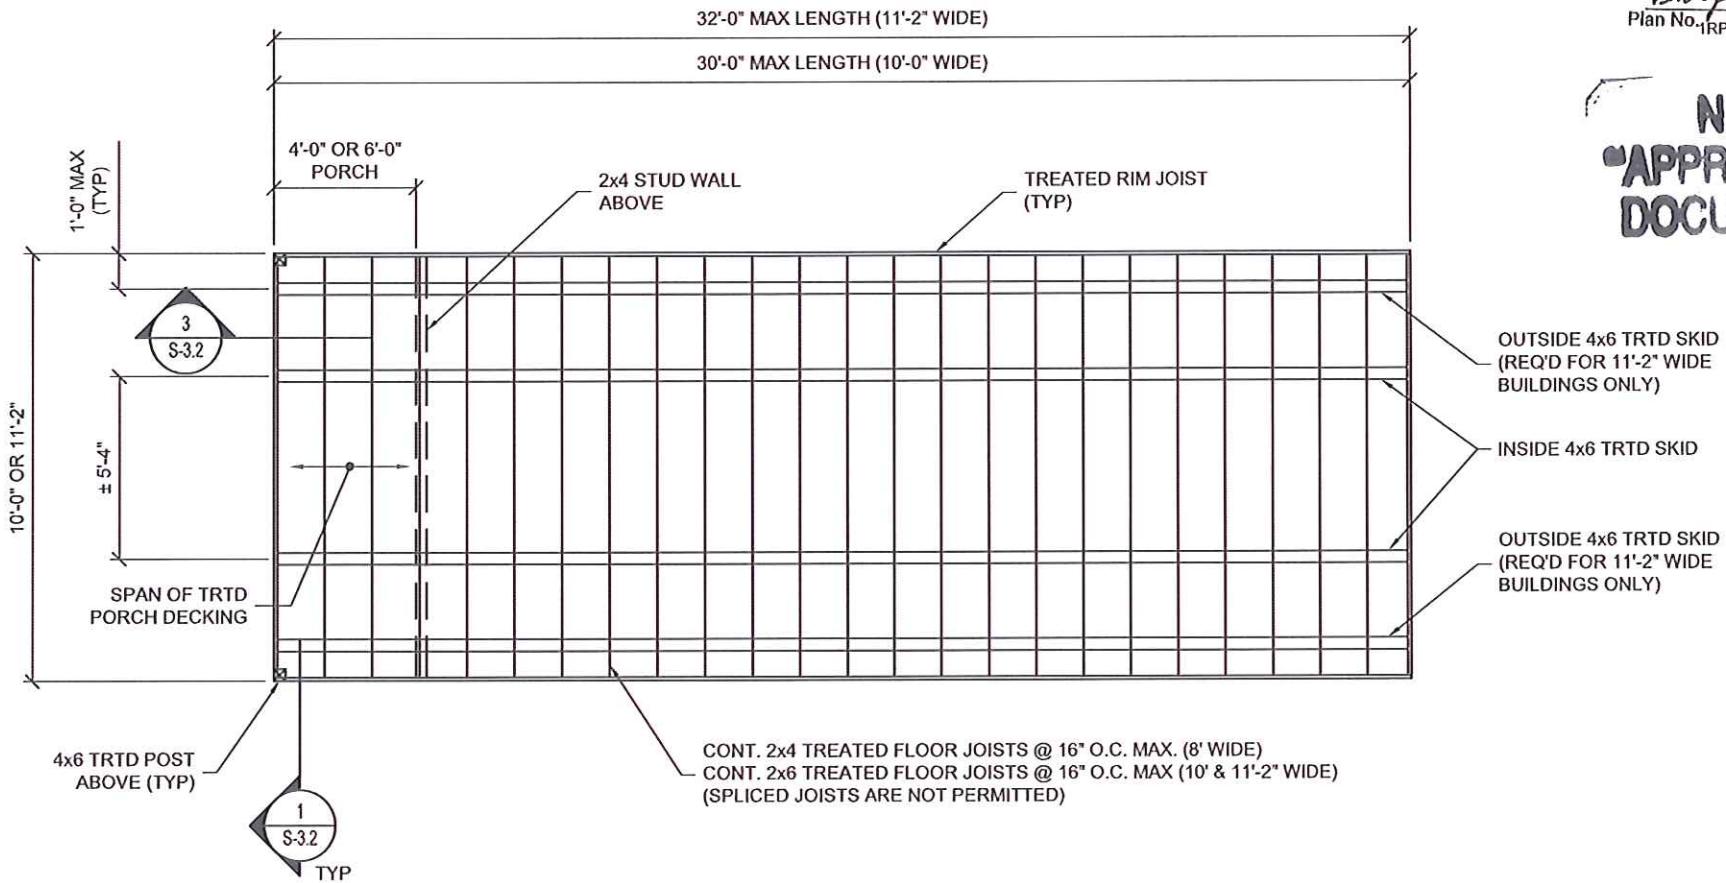
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LOFTED BARN CABIN FLOOR FRAMING PLAN (OPTIONAL)



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K. Nolan
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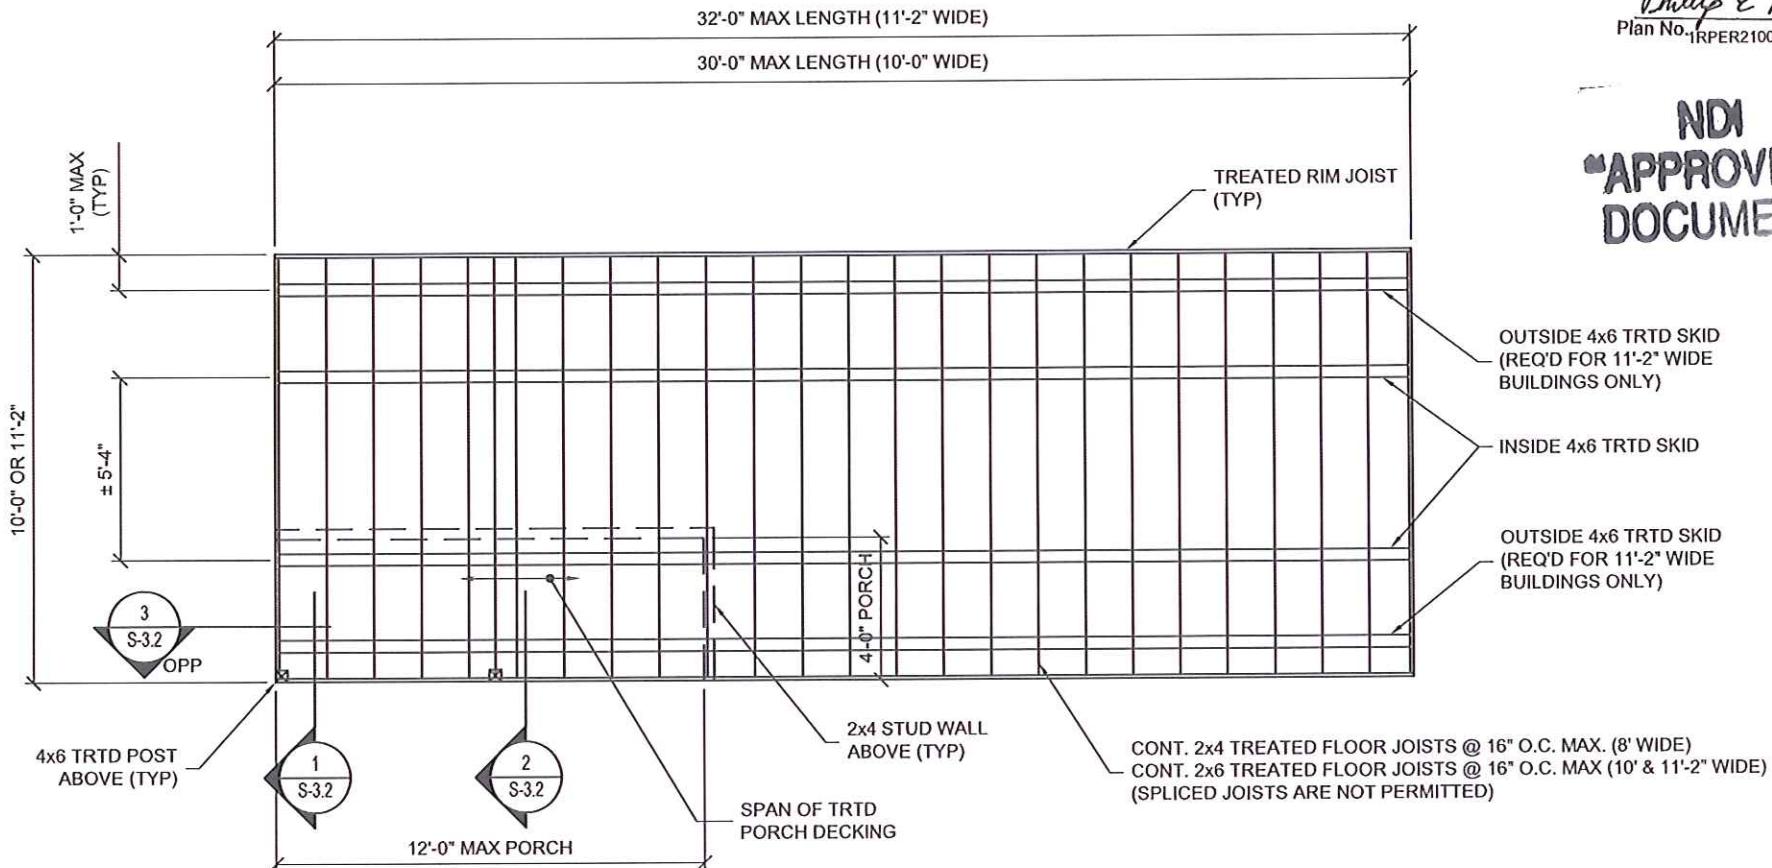
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Florida PE-49070
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SIDE LOFTED BARN CABIN FLOOR FRAMING PLAN (OPTIONAL)



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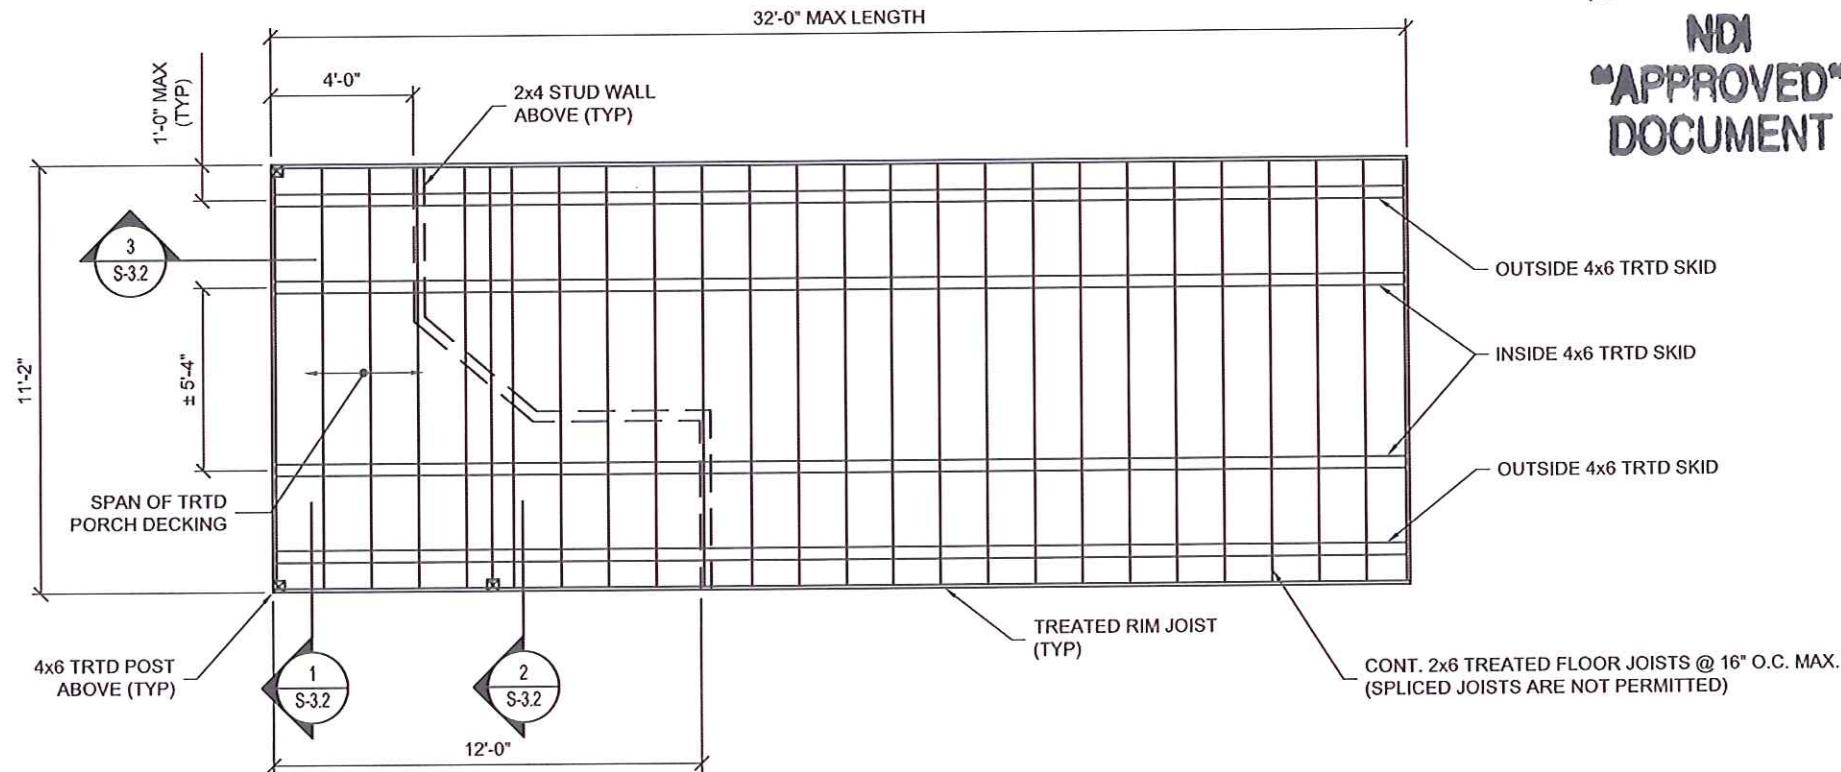
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Approved by Phillip E Robbins
Florida PE-49070
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DELUXE LOFTED BARN CABIN FLOOR FRAMING PLAN (OPTIONAL)



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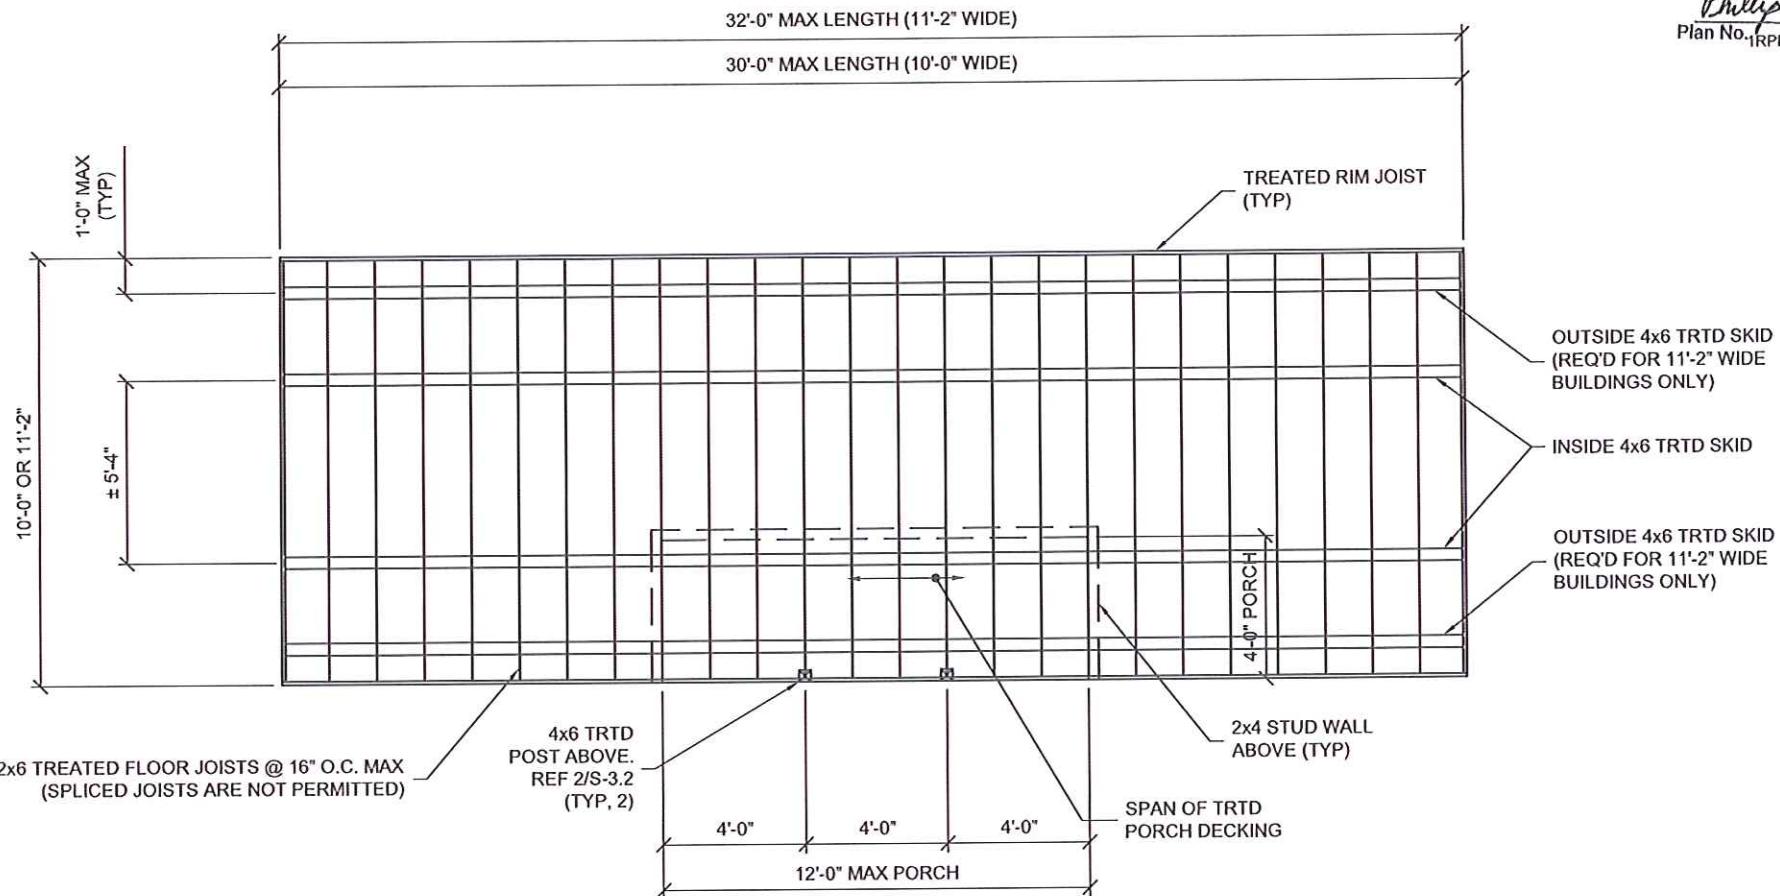
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Phillip E Robbins
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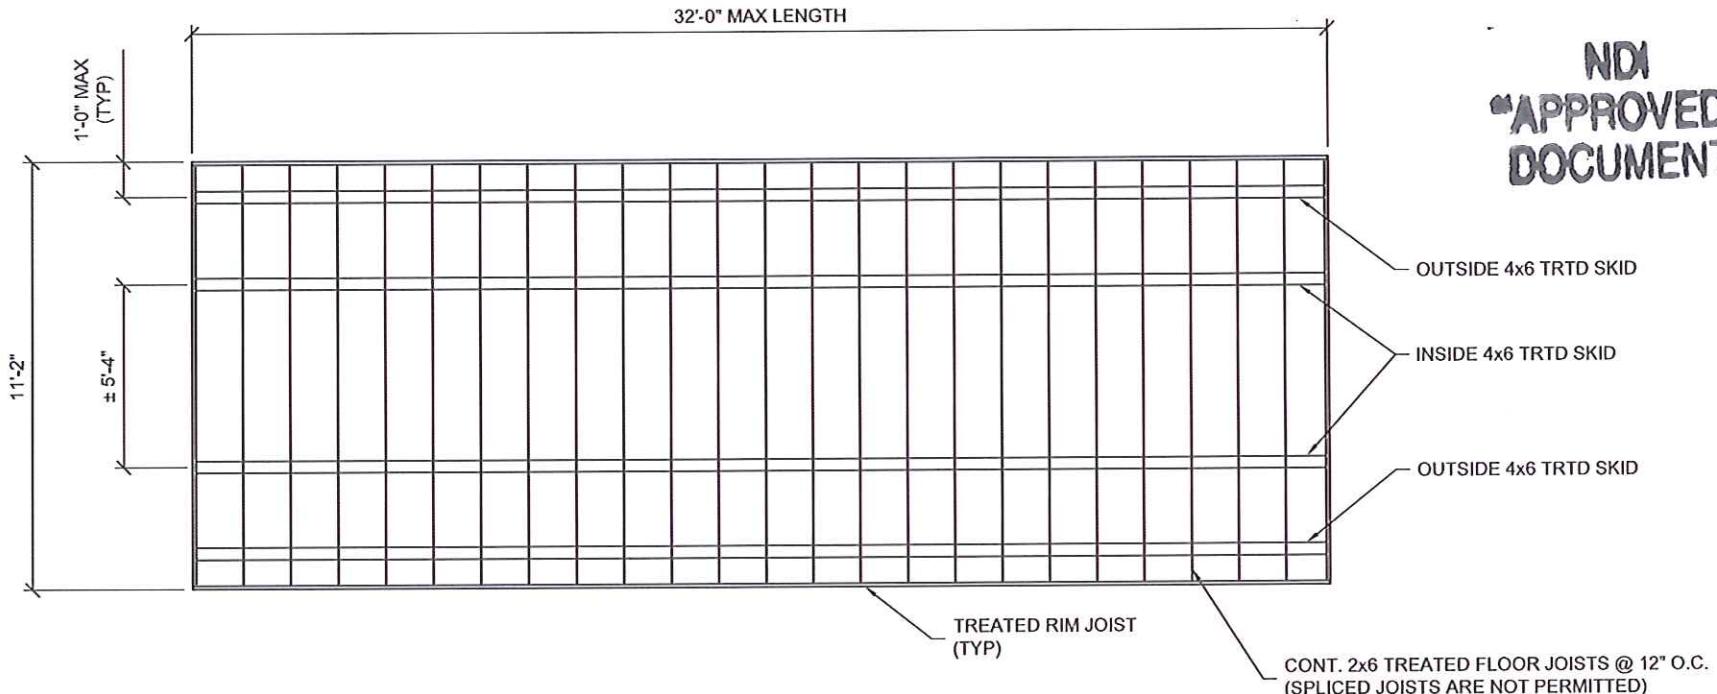
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S-14-LB
SCALE: NOT TO SCALE

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Florida PE-49070
Phillip E Robbins
Plan No. 1RPER210076 Date: 03/27/2023



LOFTED BARN w/ ROLL-UP DOOR FLOOR FRAMING PLAN (OPTIONAL)



LOFTED BARN--FLORIDA--WIND=160 MPH--FBC 2020

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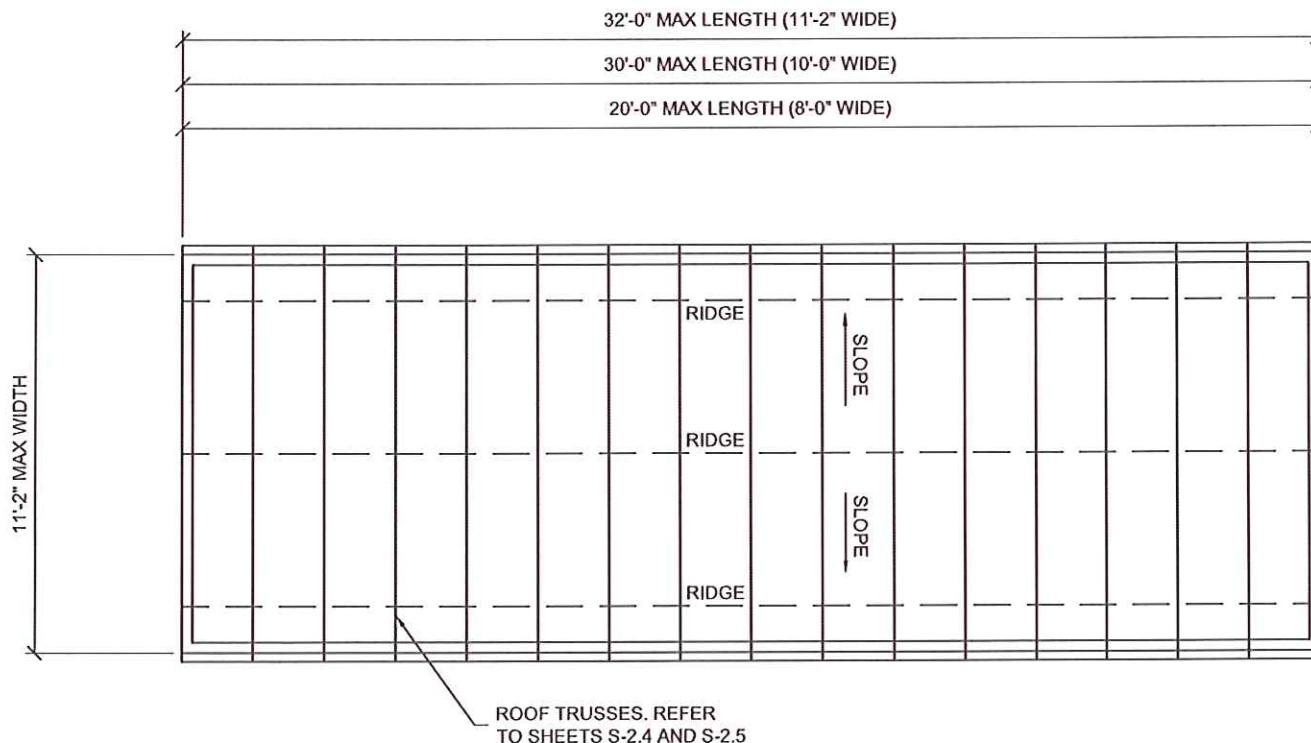
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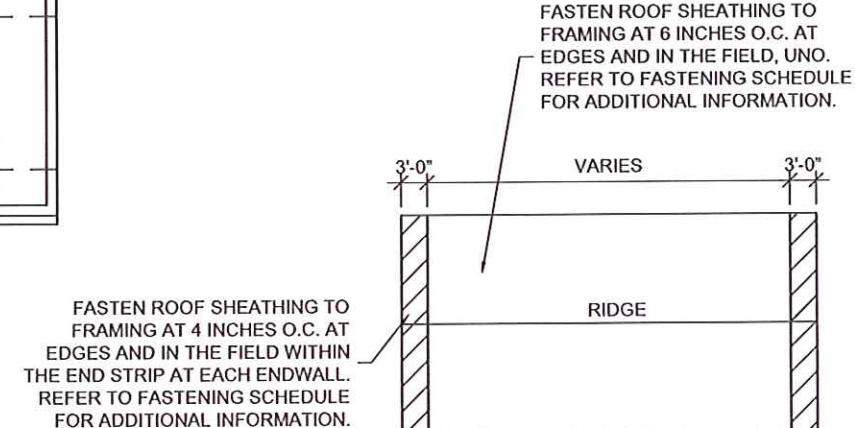
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Approved by Phillip E Robbins
Florida PE-49070
Phillip E Robbins
Plan No. 1RPER210076 Date: 03/27/2023

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ROOF FRAMING PLAN



ROOF SHEATHING DIAGRAM



LOFTED BARN--FLORIDA--WIND=160 MPH--FBC 2020


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DN: 0.9.2342.19200300.100.1.1=A01410C0
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cn=Kevin Nolan, c=US
Date: 2023.03.22 13:49:25 -05'00'


Weather King®
PORTABLE BUILDINGS

PROJECT NO:
DATE: 09-28-2021
DRAWN BY: KLN
CHECKED BY: KLN
REVISION: 03-22-2023

SHEET NUMBER
S-16-LB
SCALE: NOT TO SCALE

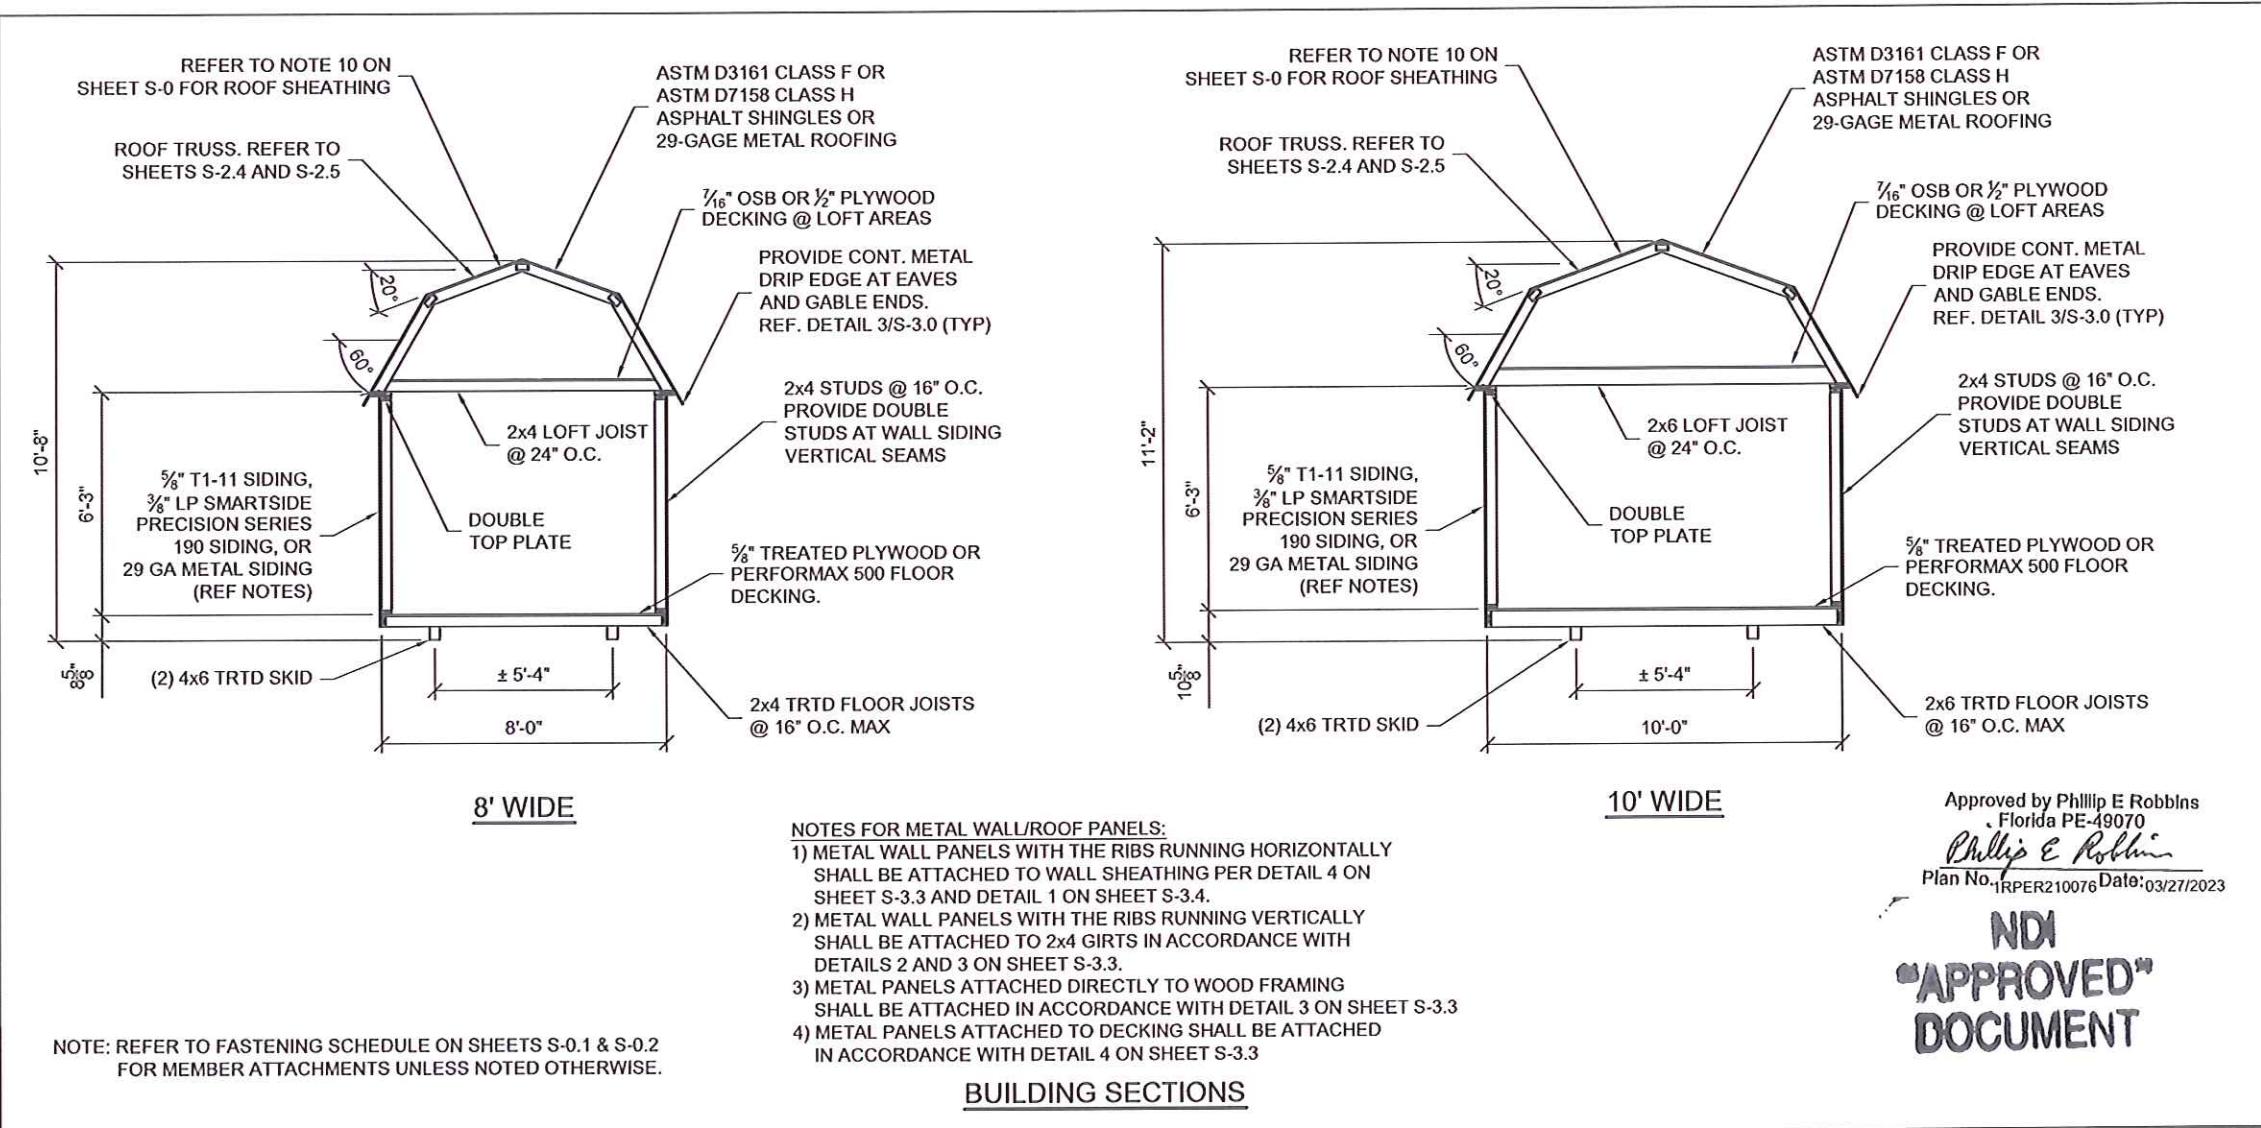

<p>KEVIN L. NOLAN LICENSE No.77209 STATE OF FLORIDA PROFESSIONAL ENGINEER</p> <p><i>[Handwritten signature]</i></p> <p>Digitally signed by Kevin Nolan DN: 0.9.2342.19200300.100.1.1=A01410 C00000179D834EF80000196AF, cn=Kevin Nolan, c=US Date: 2023.03.22 13:49:58 -05'00'</p> <p>1. This item has been electronically signed and sealed by Kevin L Nolan, PE on 03/22/2023 using a digital signature. 2. Printed copies of this document are not considered signed and sealed and the signature must be verified on any electronic copy.</p>	<h1>LOFTED BARN--FLORIDA--WIND=160 MPH--FBC 2020</h1> <p>Weather King® PORTABLE BUILDINGS</p>	
	<p>PROJECT NO: DATE: 09-28-2021 DRAWN BY: KLN CHECKED BY: KLN REVISION:</p>	<p>SHEET NUMBER S-20-LB SCALE: 1/4" = 1'-0"</p>

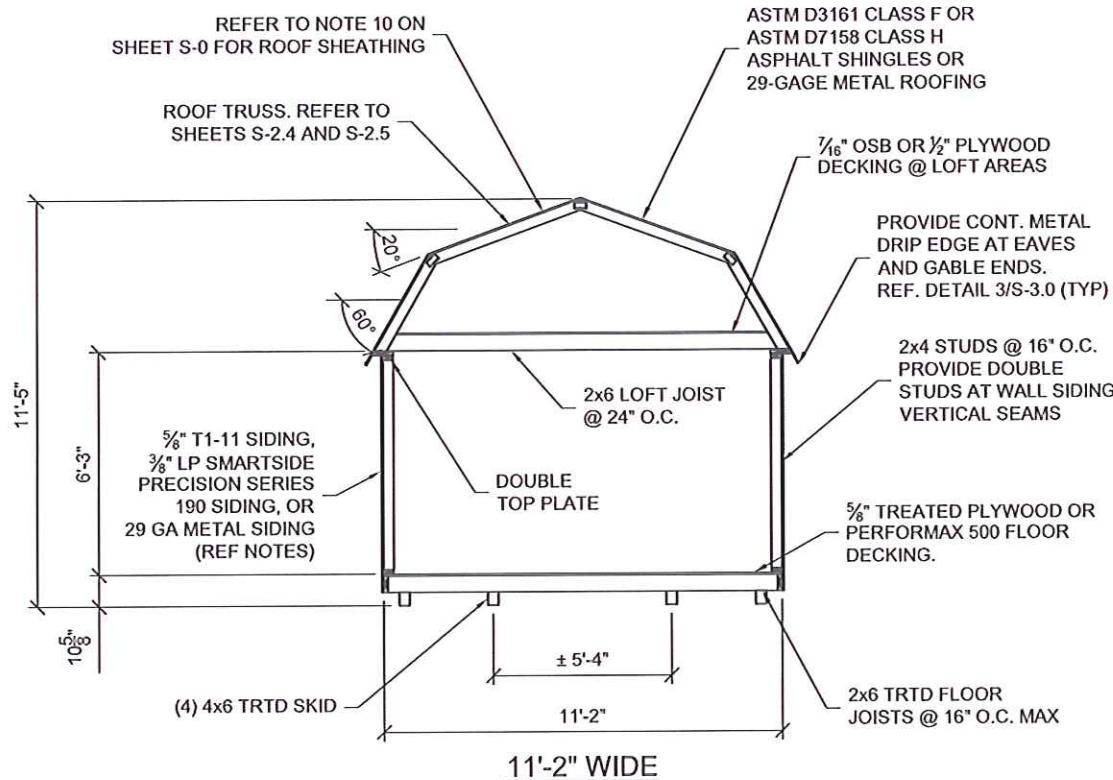

NOTES FOR METAL WALL/ROOF PANELS:

- 1) METAL WALL PANELS WITH THE RIBS RUNNING HORIZONTALLY SHALL BE ATTACHED TO WALL SHEATHING PER DETAIL 4 ON SHEET S-3.3 AND DETAIL 1 ON SHEET S-3.4.
- 2) METAL WALL PANELS WITH THE RIBS RUNNING VERTICALLY SHALL BE ATTACHED TO 2x4 GIRTS IN ACCORDANCE WITH DETAILS 2 AND 3 ON SHEET S-3.3.
- 3) METAL PANELS ATTACHED DIRECTLY TO WOOD FRAMING SHALL BE ATTACHED IN ACCORDANCE WITH DETAIL 3 ON SHEET S-3.3.
- 4) METAL PANELS ATTACHED TO DECKING SHALL BE ATTACHED IN ACCORDANCE WITH DETAIL 4 ON SHEET S-3.3.

Approved by Phillip E Robbins
 Florida PE-49070
 Phillip E Robbins
 Plan No. 1RPER210076 Date: 03/27/2023

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NOTE: REFER TO FASTENING SCHEDULE ON SHEETS S-0.1 & S-0.2
 FOR MEMBER ATTACHMENTS UNLESS NOTED OTHERWISE.

BUILDING SECTION

LOFTED BARN--FLORIDA--WIND=160 MPH--FBC 2020

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 DN: 0.9.2342.19200300.100.1.1=A01410C0
 0000179D834EF80000196AF,
 cn=Kevin Nolan, c=US
 Date: 2023.03.22 13:50:28 -05'00'

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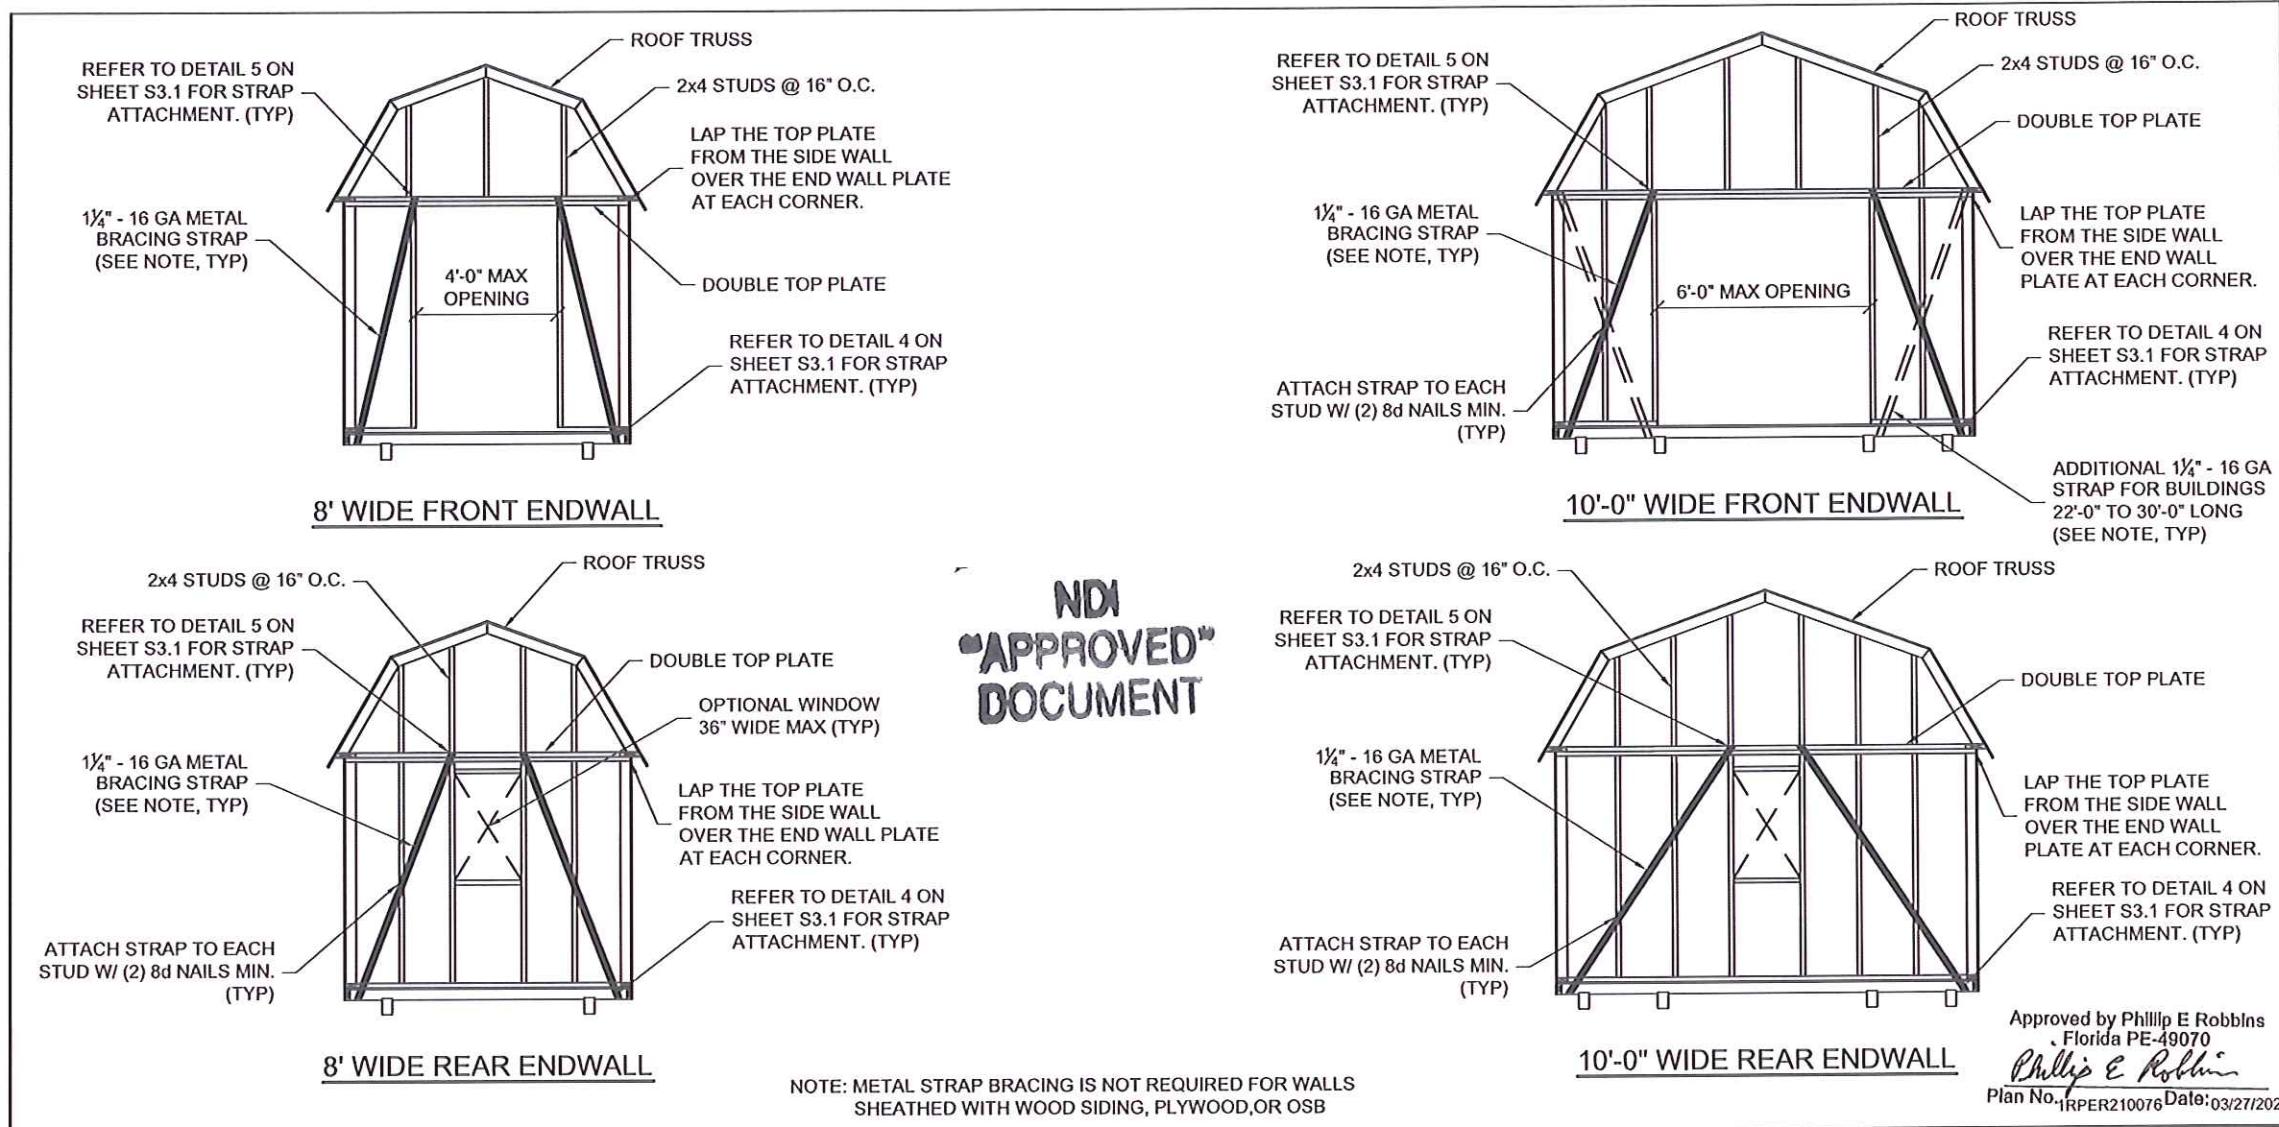
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REVISION:


SHEET NUMBER

S-21-LB

SCALE: 1/4" = 1'-0"



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Florida PE-49070
Phillip E Robbins
Plan No: 1RPER210076 Date: 03/27/2023

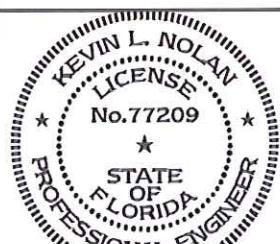

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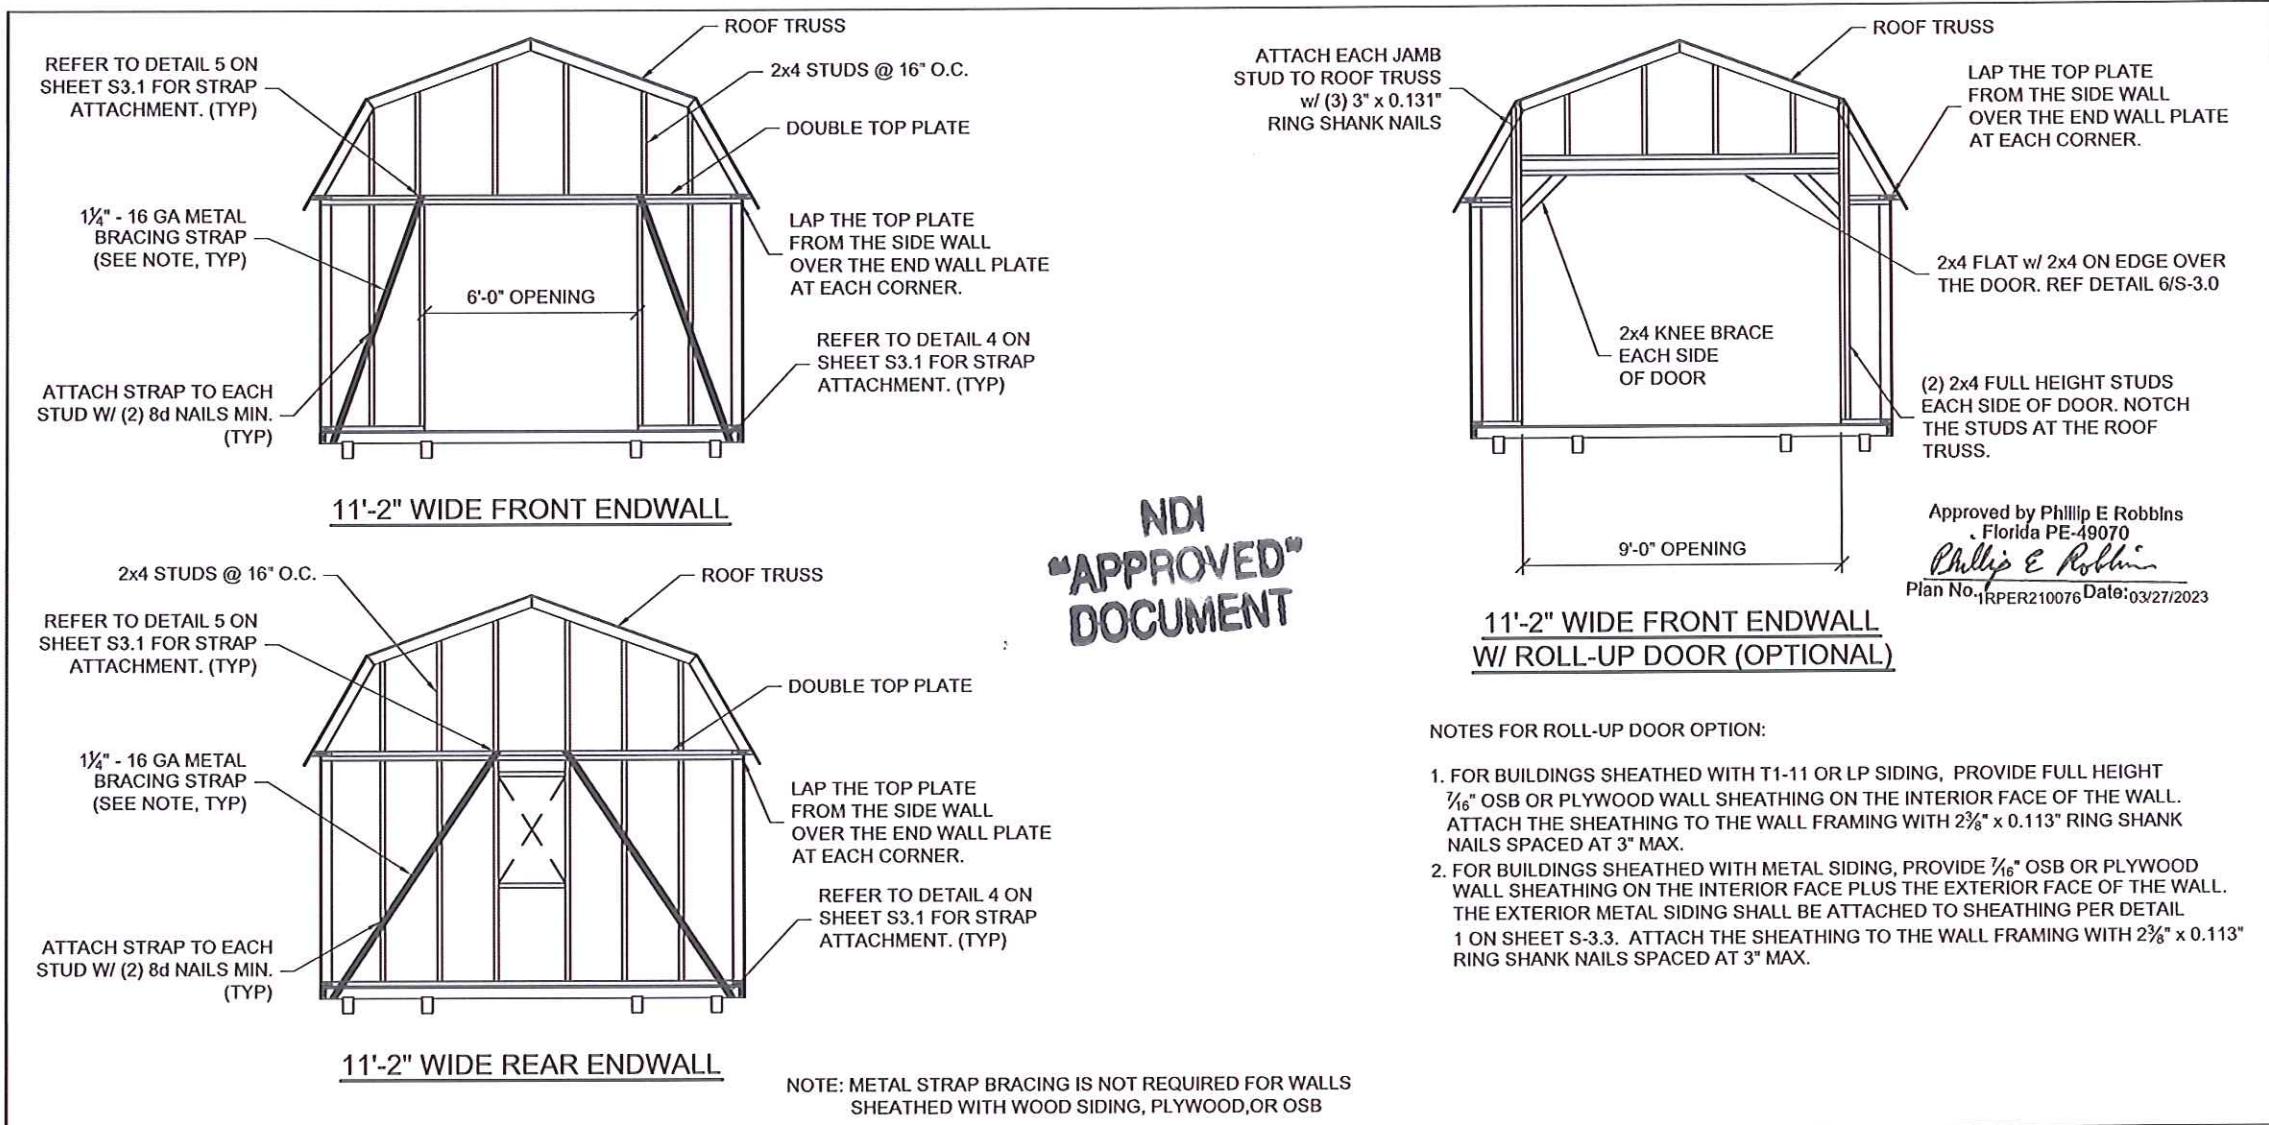
LOFTED BARN--FLORIDA--WIND=160 MPH--FBC 2020

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c=US
Date: 2023.03.22 13:51:05 -05'00'

Kevin Nolan

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PORTABLE BUILDINGS





PROJECT NO:	SHEET NUMBER
DATE: 09-28-2021	S-22-LB
DRAWN BY: KLN	
CHECKED BY: KLN	
REVISION:	SCALE: NOT TO SCALE



<p>Digitally signed by Kevin Nolan DN: 0.9.2342.19200300.100.1.1=A01410C00 000179D834EF80000196AF, cn=Kevin Nolan, c=US Date: 2023.03.22 13:52:40 -05'00'</p> <p><i>K. Nolan</i></p> <p>1. This item has been electronically signed and sealed by Kevin L Nolan, PE on 03/22/2023 using a digital signature. 2. Printed copies of this document are not considered signed and sealed and the signature must be verified on any electronic copy.</p>	<h1>LOFTED BARN--FLORIDA--WIND=160 MPH--FBC 2020</h1> <p>Weather King® PORTABLE BUILDINGS</p>	
	<p>PROJECT NO:</p> <p>DATE: 09-28-2021</p> <p>DRAWN BY: KLN</p> <p>CHECKED BY: KLN</p> <p>REVISION:</p>	<p>SHEET NUMBER</p> <p>S-23-LB</p> <p>SCALE: NOT TO SCALE</p>


GENERAL NOTES:

1. REFER TO SHEET S-0 FOR DESIGN LOADS.
2. MAXIMUM TRUSS SPACING = 24" O.C. UNLESS NOTED OTHERWISE.
3. TRUSS TOP CHORD SHALL BE BRACED W/ STRUCTURAL WOOD SHEATHING ATTACHED DIRECTLY TO TRUSS MEMBERS.
4. ALL TRUSS MEMBERS ARE TO BE SPF #2 OR BETTER.
5. TRUSS PLATES ARE TO BE A MINIMUM OF 20 GAGE (MT20) HYDRAULICALLY PRESSED IN PLACE EACH SIDE OF TRUSS.
6. REACTIONS DUE TO WIND ARE BASED ON MWFRS END ZONE PRESSURES. INDIVIDUAL MEMBERS DESIGNED FOR COMPONENTS AND CLADDING WIND PRESSURE.
7. DEFLECTION MEETS L/240 LIVE LOAD AND L/180 TOTAL LOAD.
8. LOAD DURATION ADJUSTMENT FACTORS:
ROOF LIVE: 1.25
WIND: 1.60
9. REPETITIVE MEMBER INCREASE: 1.15
10. HORIZONTAL THRUST IS TO BE RESISTED BY LOFT JOISTS. REFER TO SHEETS S-2.0, S-2.1, AND S-3.0 FOR LOFT JOIST SIZE, AND ATTACHMENT INFORMATION.

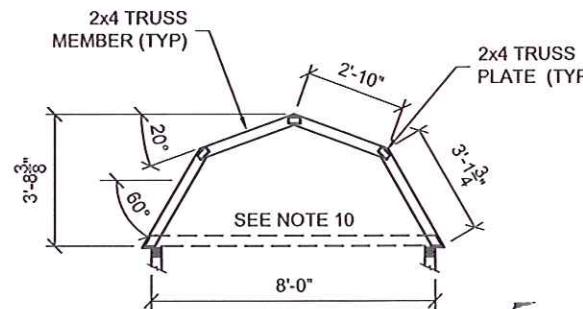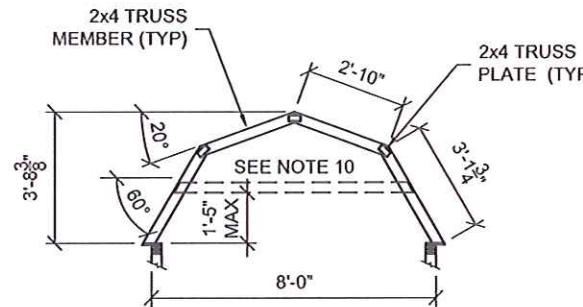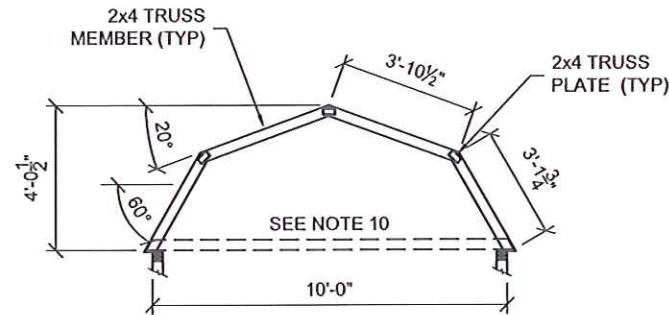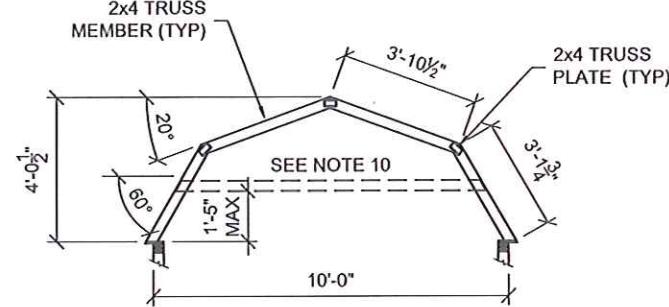8' WIDE LOFTED BARN TRUSS8' WIDE LOFTED BARN TRUSS (OPTIONAL)10' WIDE LOFTED BARN TRUSS10' WIDE LOFTED BARN TRUSS (OPTIONAL)

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DOCUMENT

Approved by Phillip E Robbins
Florida PE-49070
Phillip E Robbins
Plan No. 1RPER210076 Date: 03/27/2023

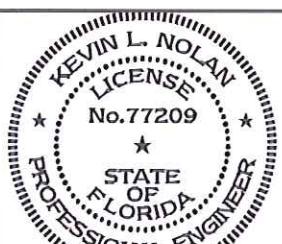

LOFTED BARN--FLORIDA--WIND=160 MPH--FBC 2020

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Digitally signed by Kevin Nolan
DN:
0.9.2342.19200300.100.1.1=A01410C000
00179D834EF80000196AF, cn=Kevin
Nolan, c=US
Date: 2023.03.22 13:53:18-05'00'

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PORTABLE BUILDINGS

PROJECT NO:

DATE: 09-28-2021

DRAWN BY: KLN



CHECKED BY: KLN

REVISION:

SHEET NUMBER

S-24-LB

SCALE: 1/4" = 1'-0"

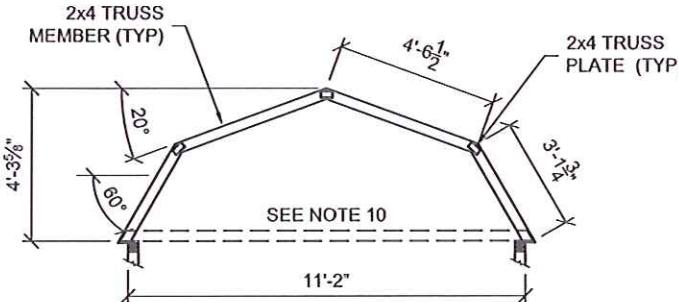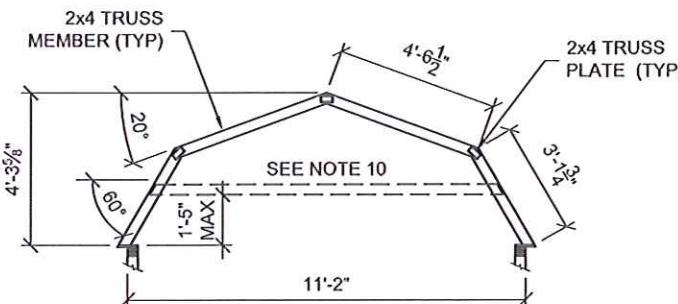11'-2" WIDE LOFTED BARN TRUSS11'-2" WIDE LOFTED BARN TRUSS (OPTIONAL)

LOFTED BARN--FLORIDA--WIND=160 MPH--FBC 2020

Digitally signed by Kevin Nolan
 DN: 0.9.2342.19200300.100.1.1=A01410C
 cn=Kevin Nolan, c=US
 Date: 2023.03.22 13:53:54 -05'00'

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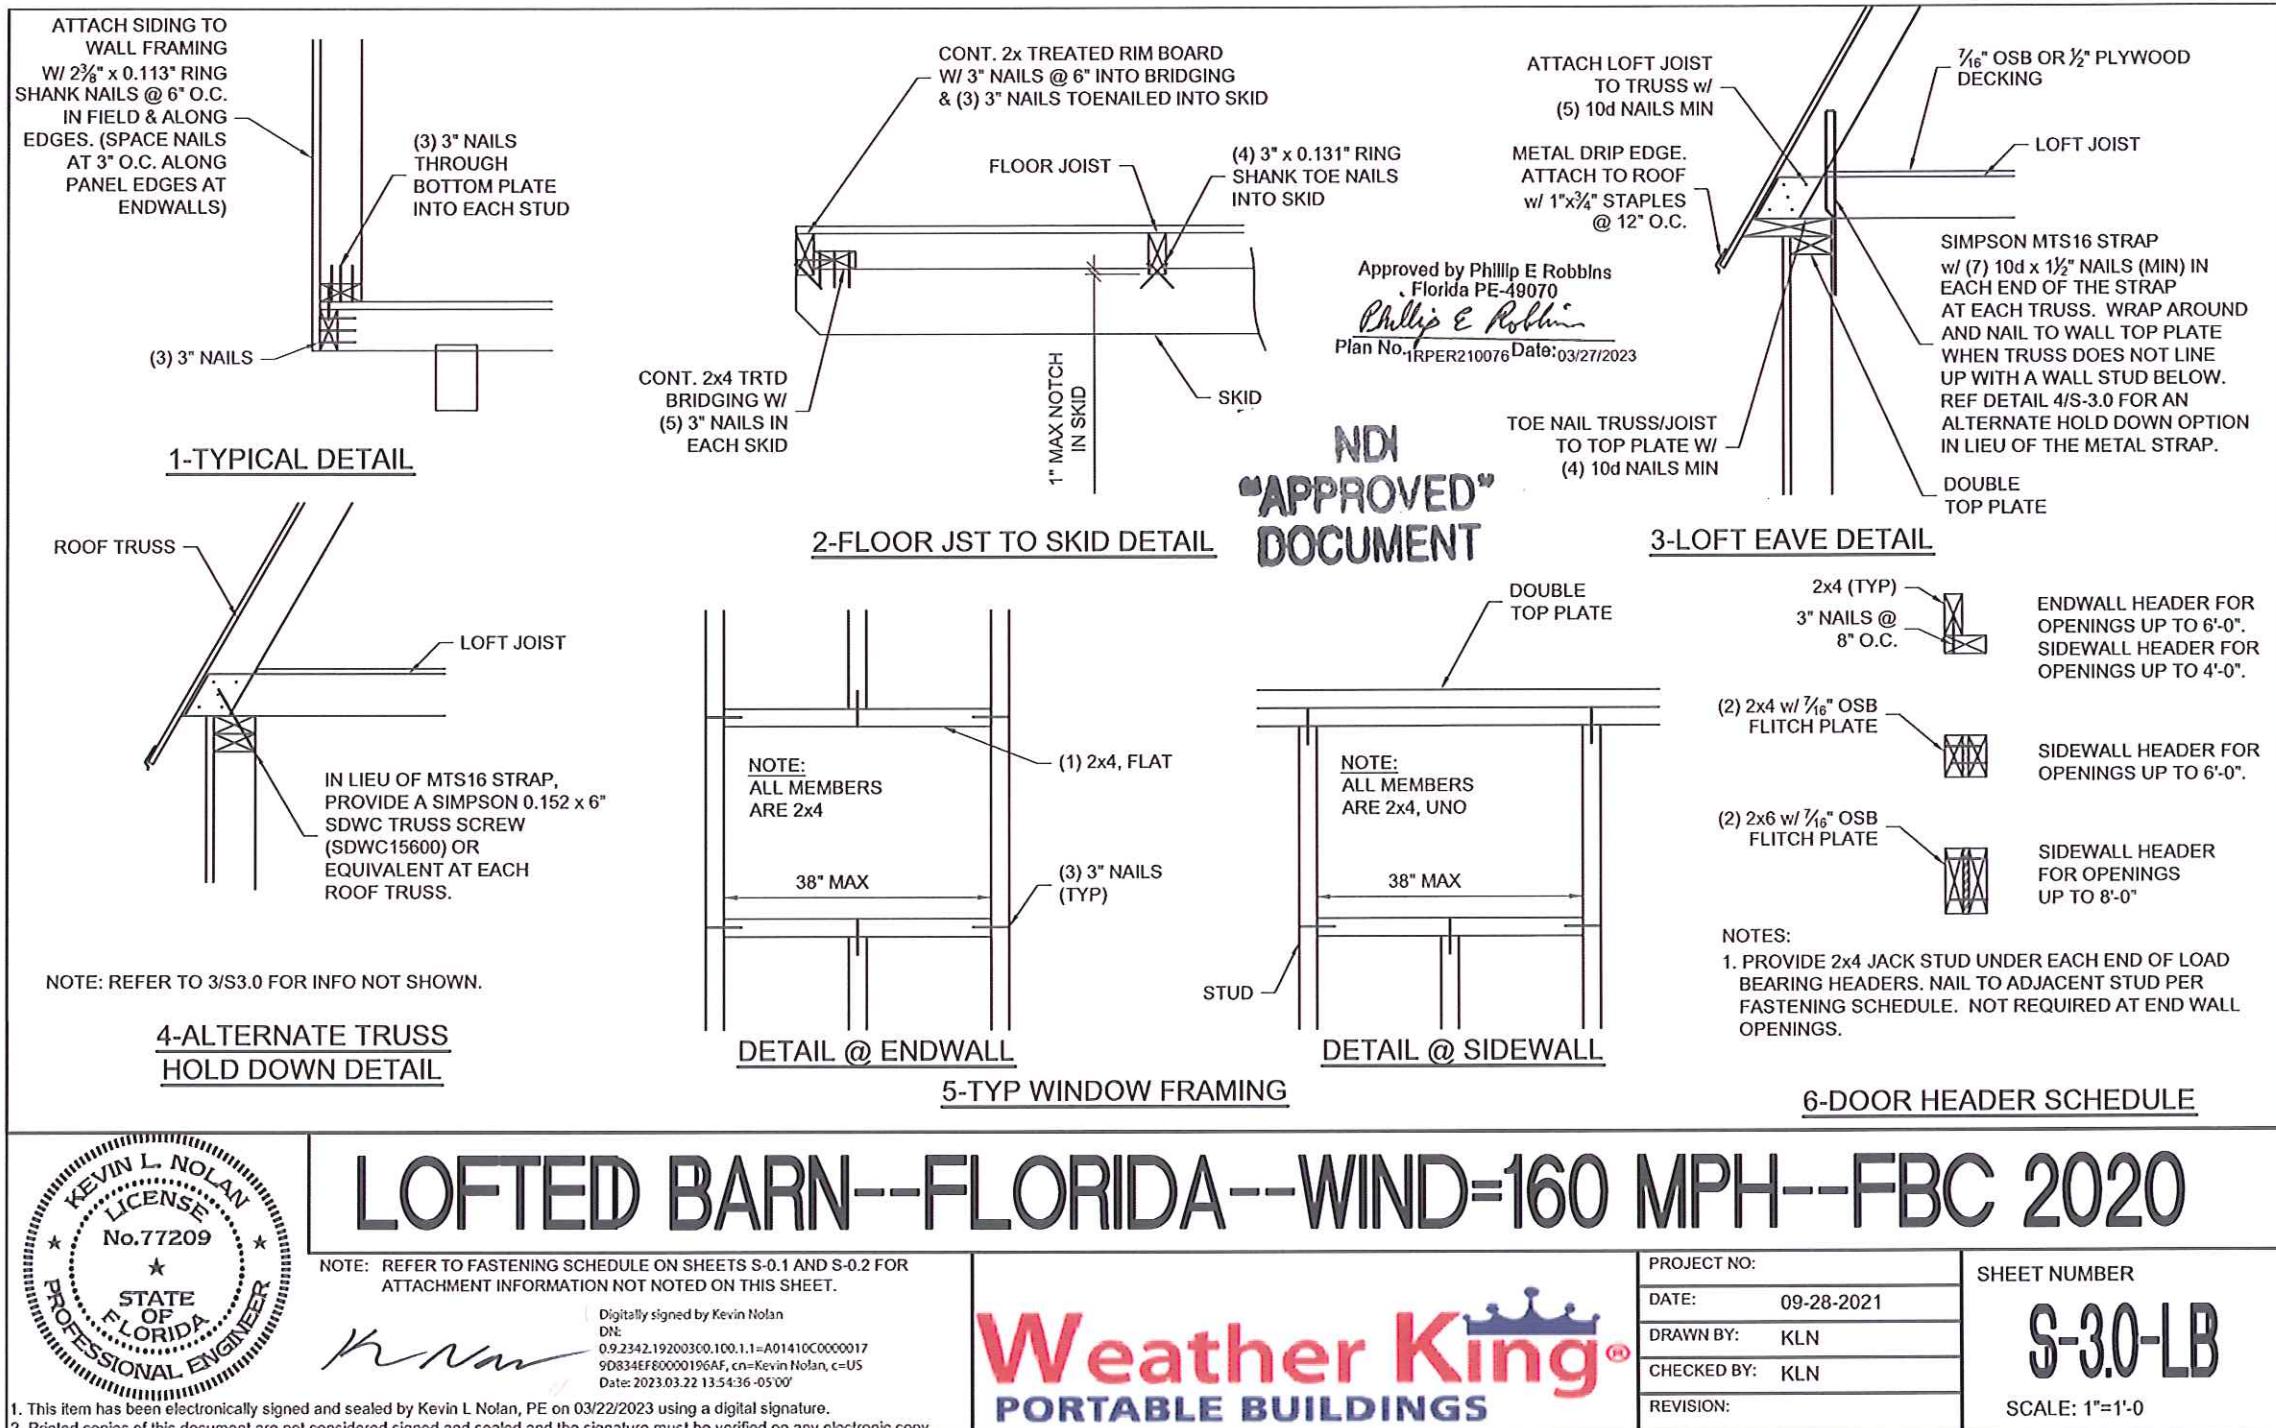
CHECKED BY: KLN


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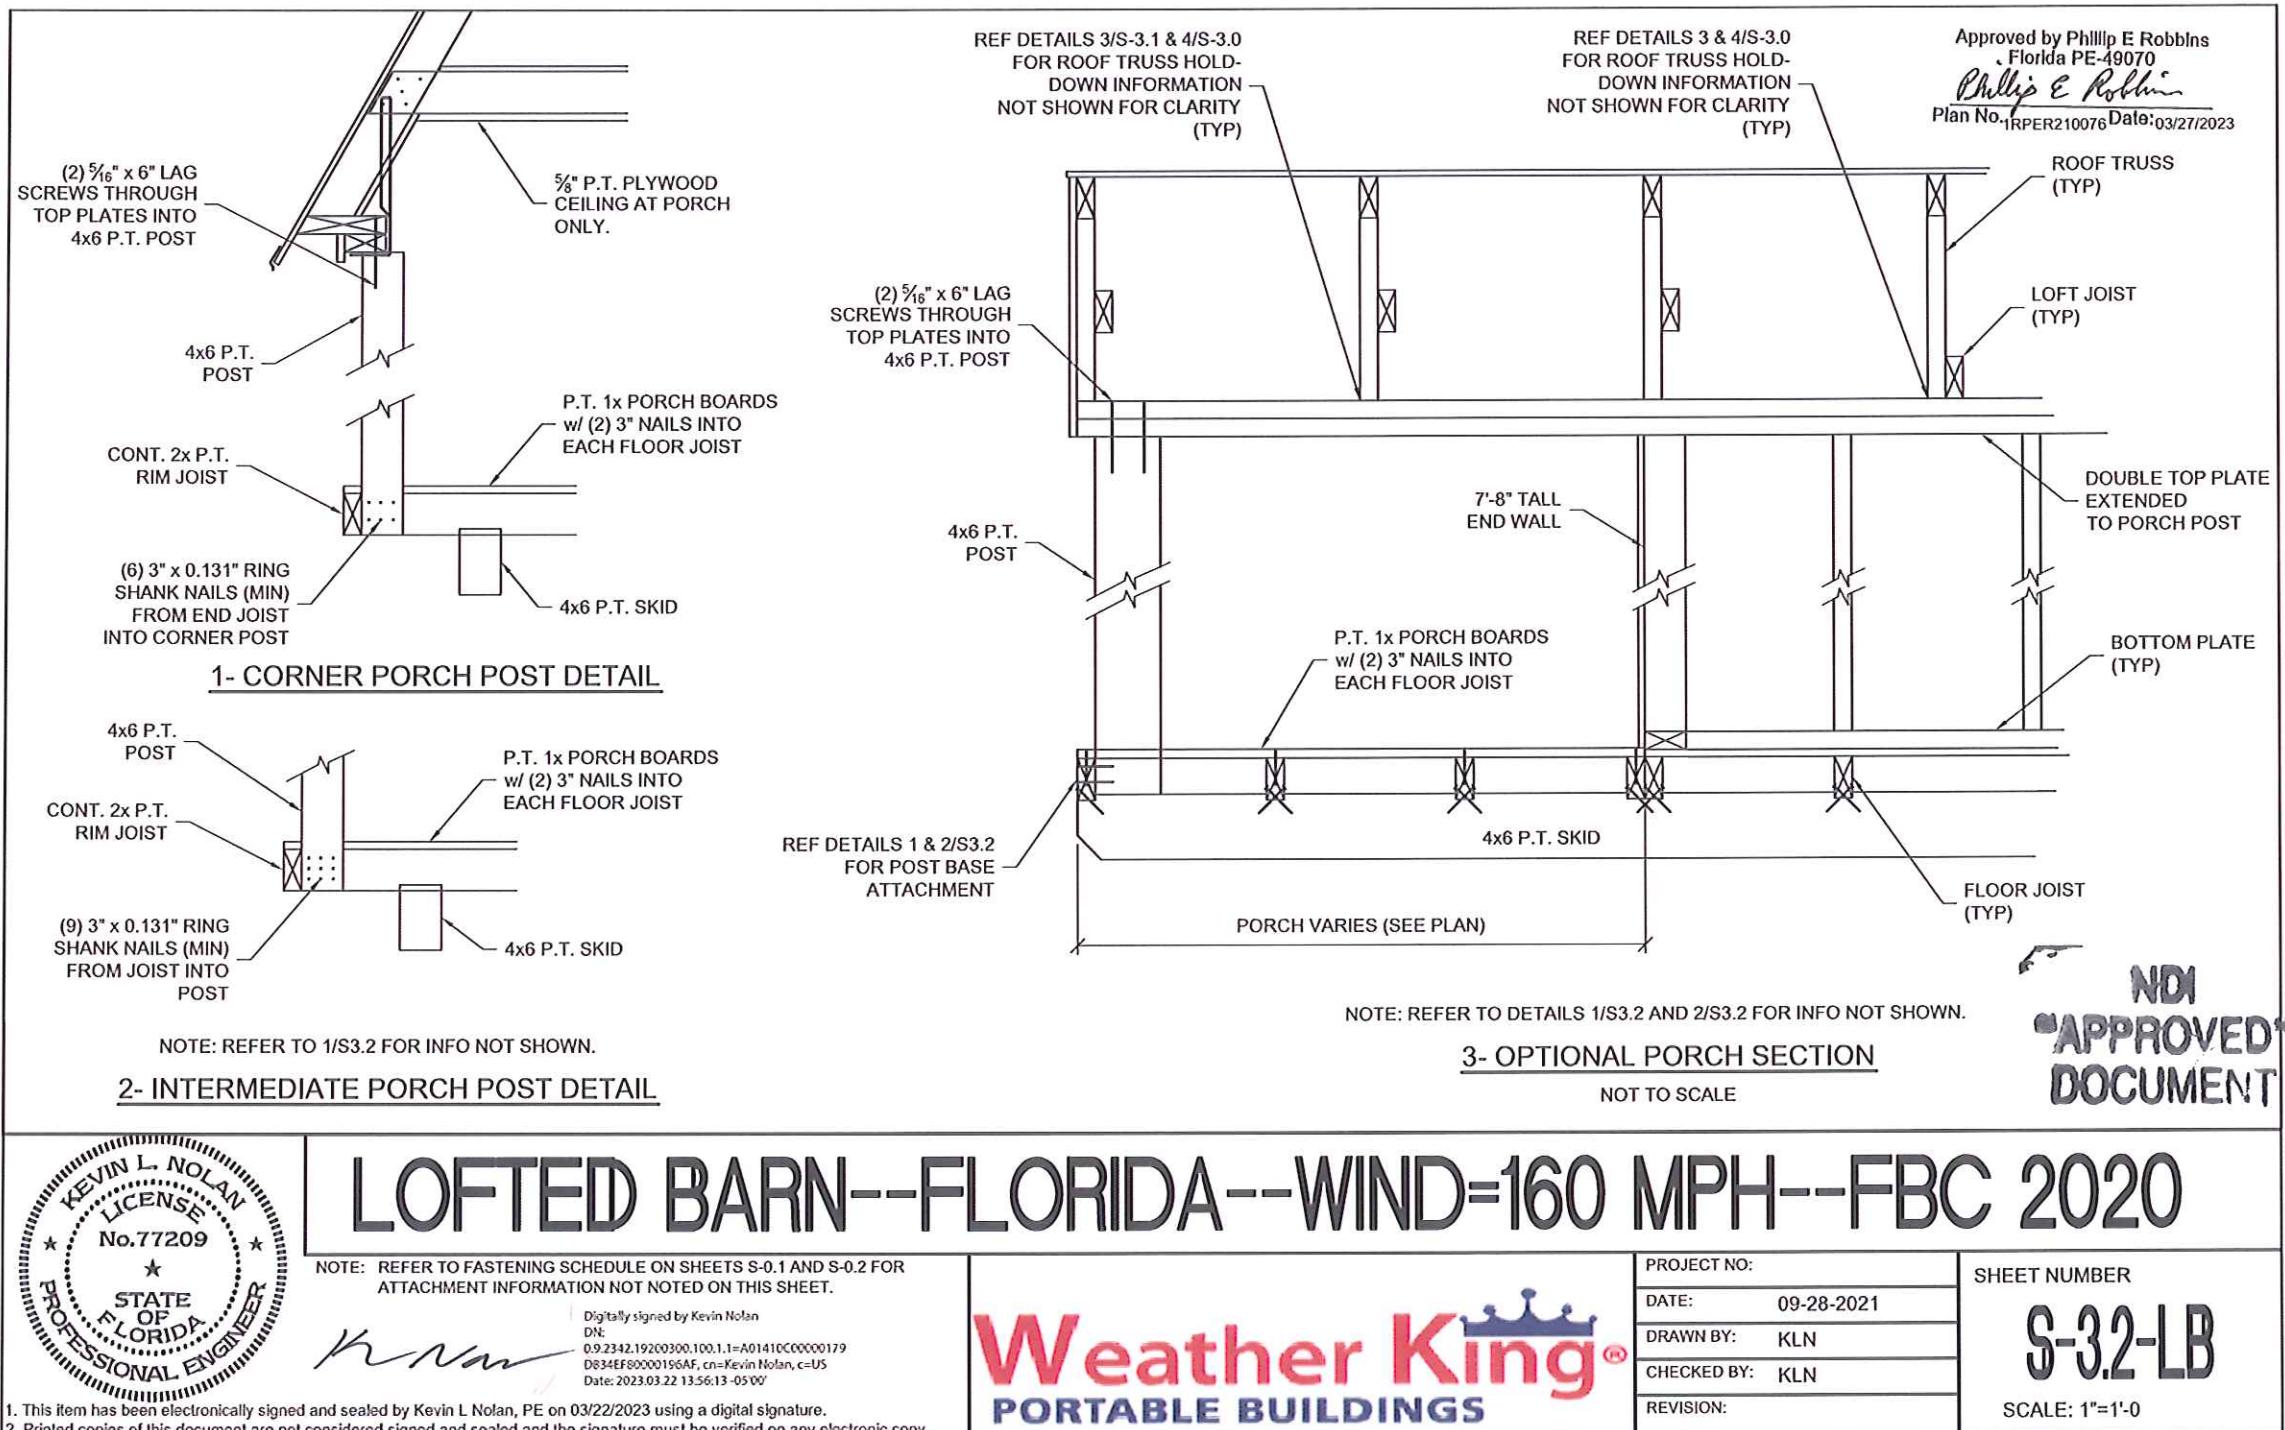
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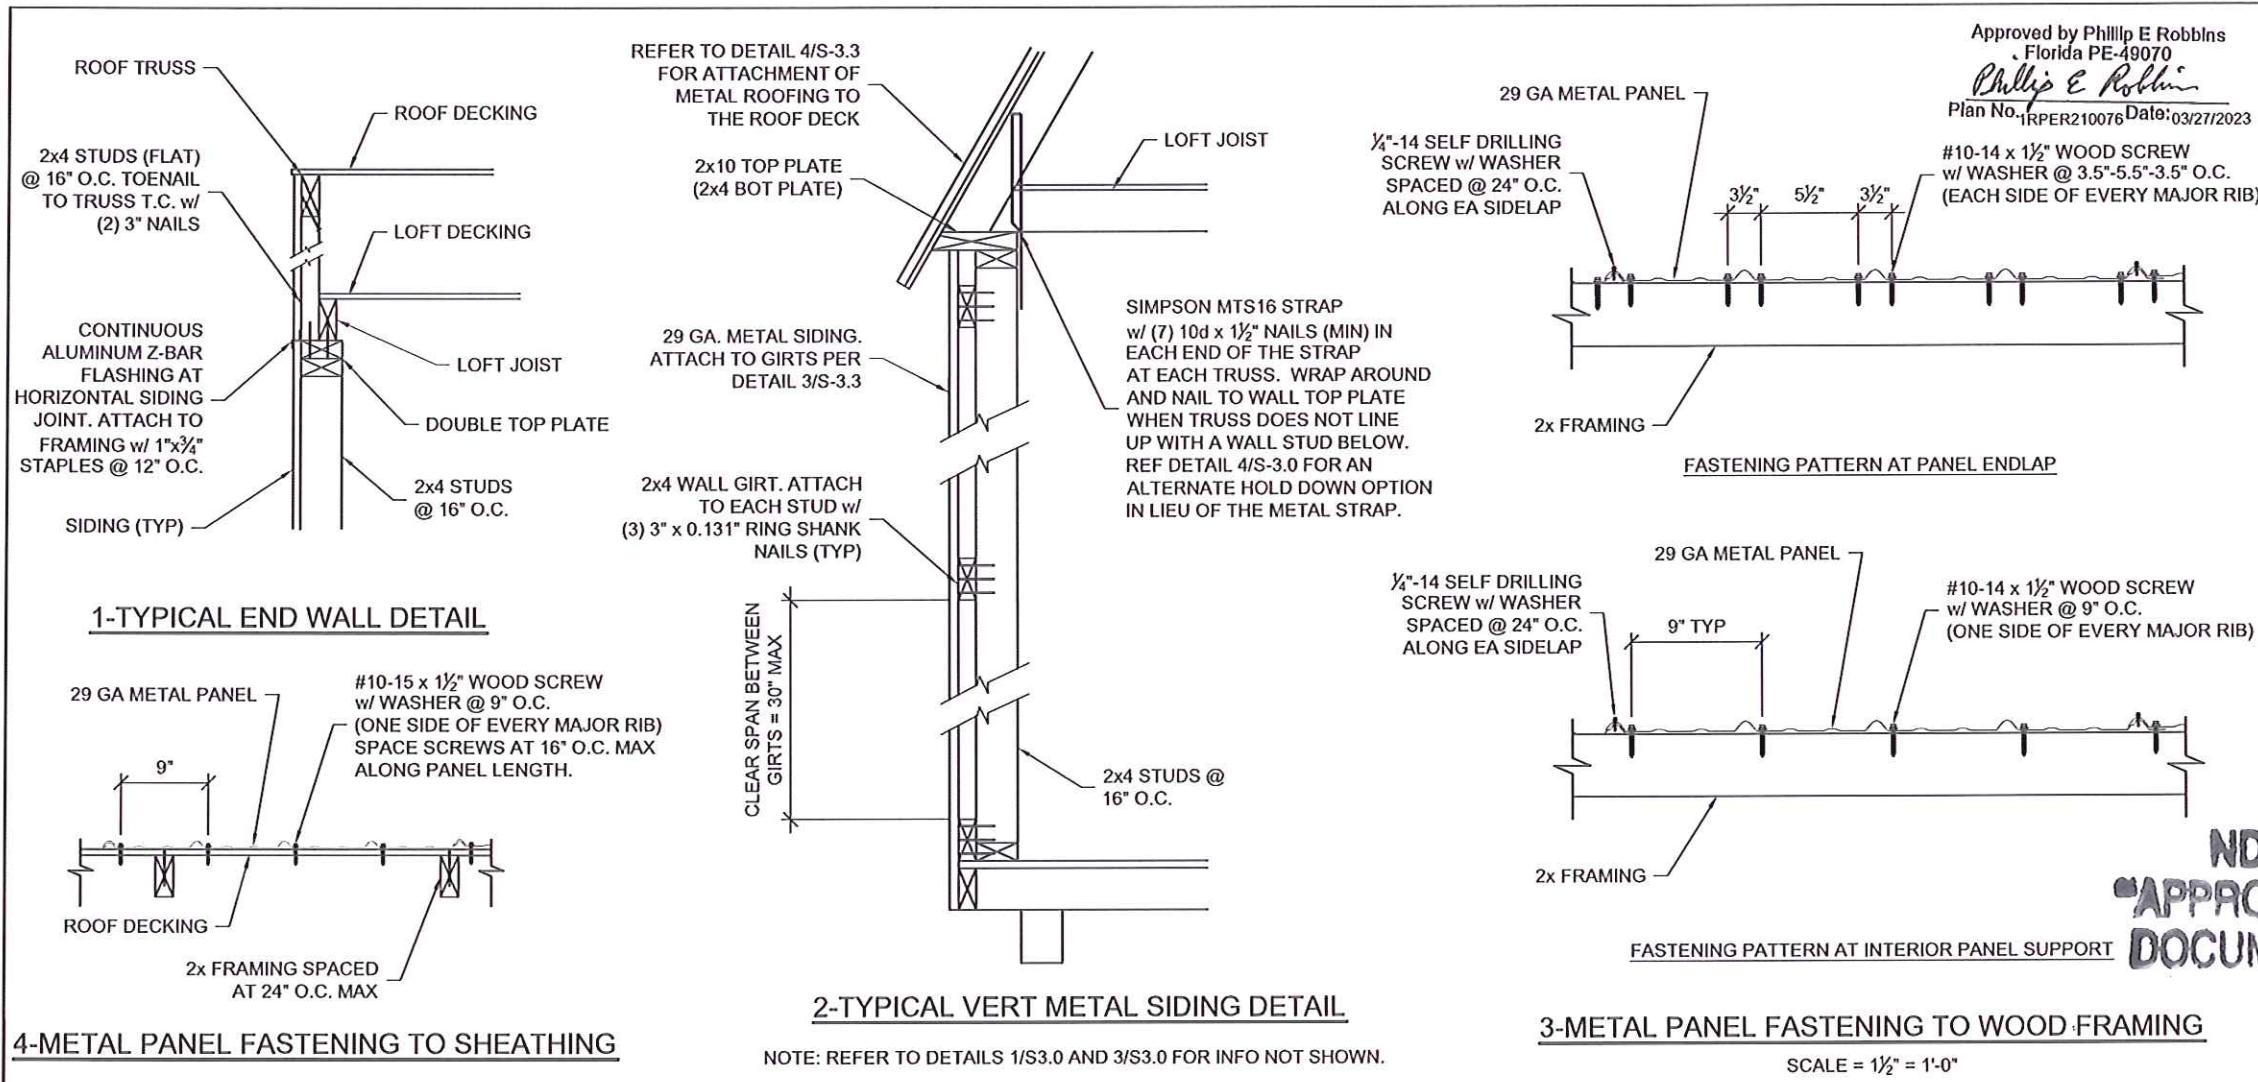
S-25-LB

SCALE: 1/4" = 1'-0"







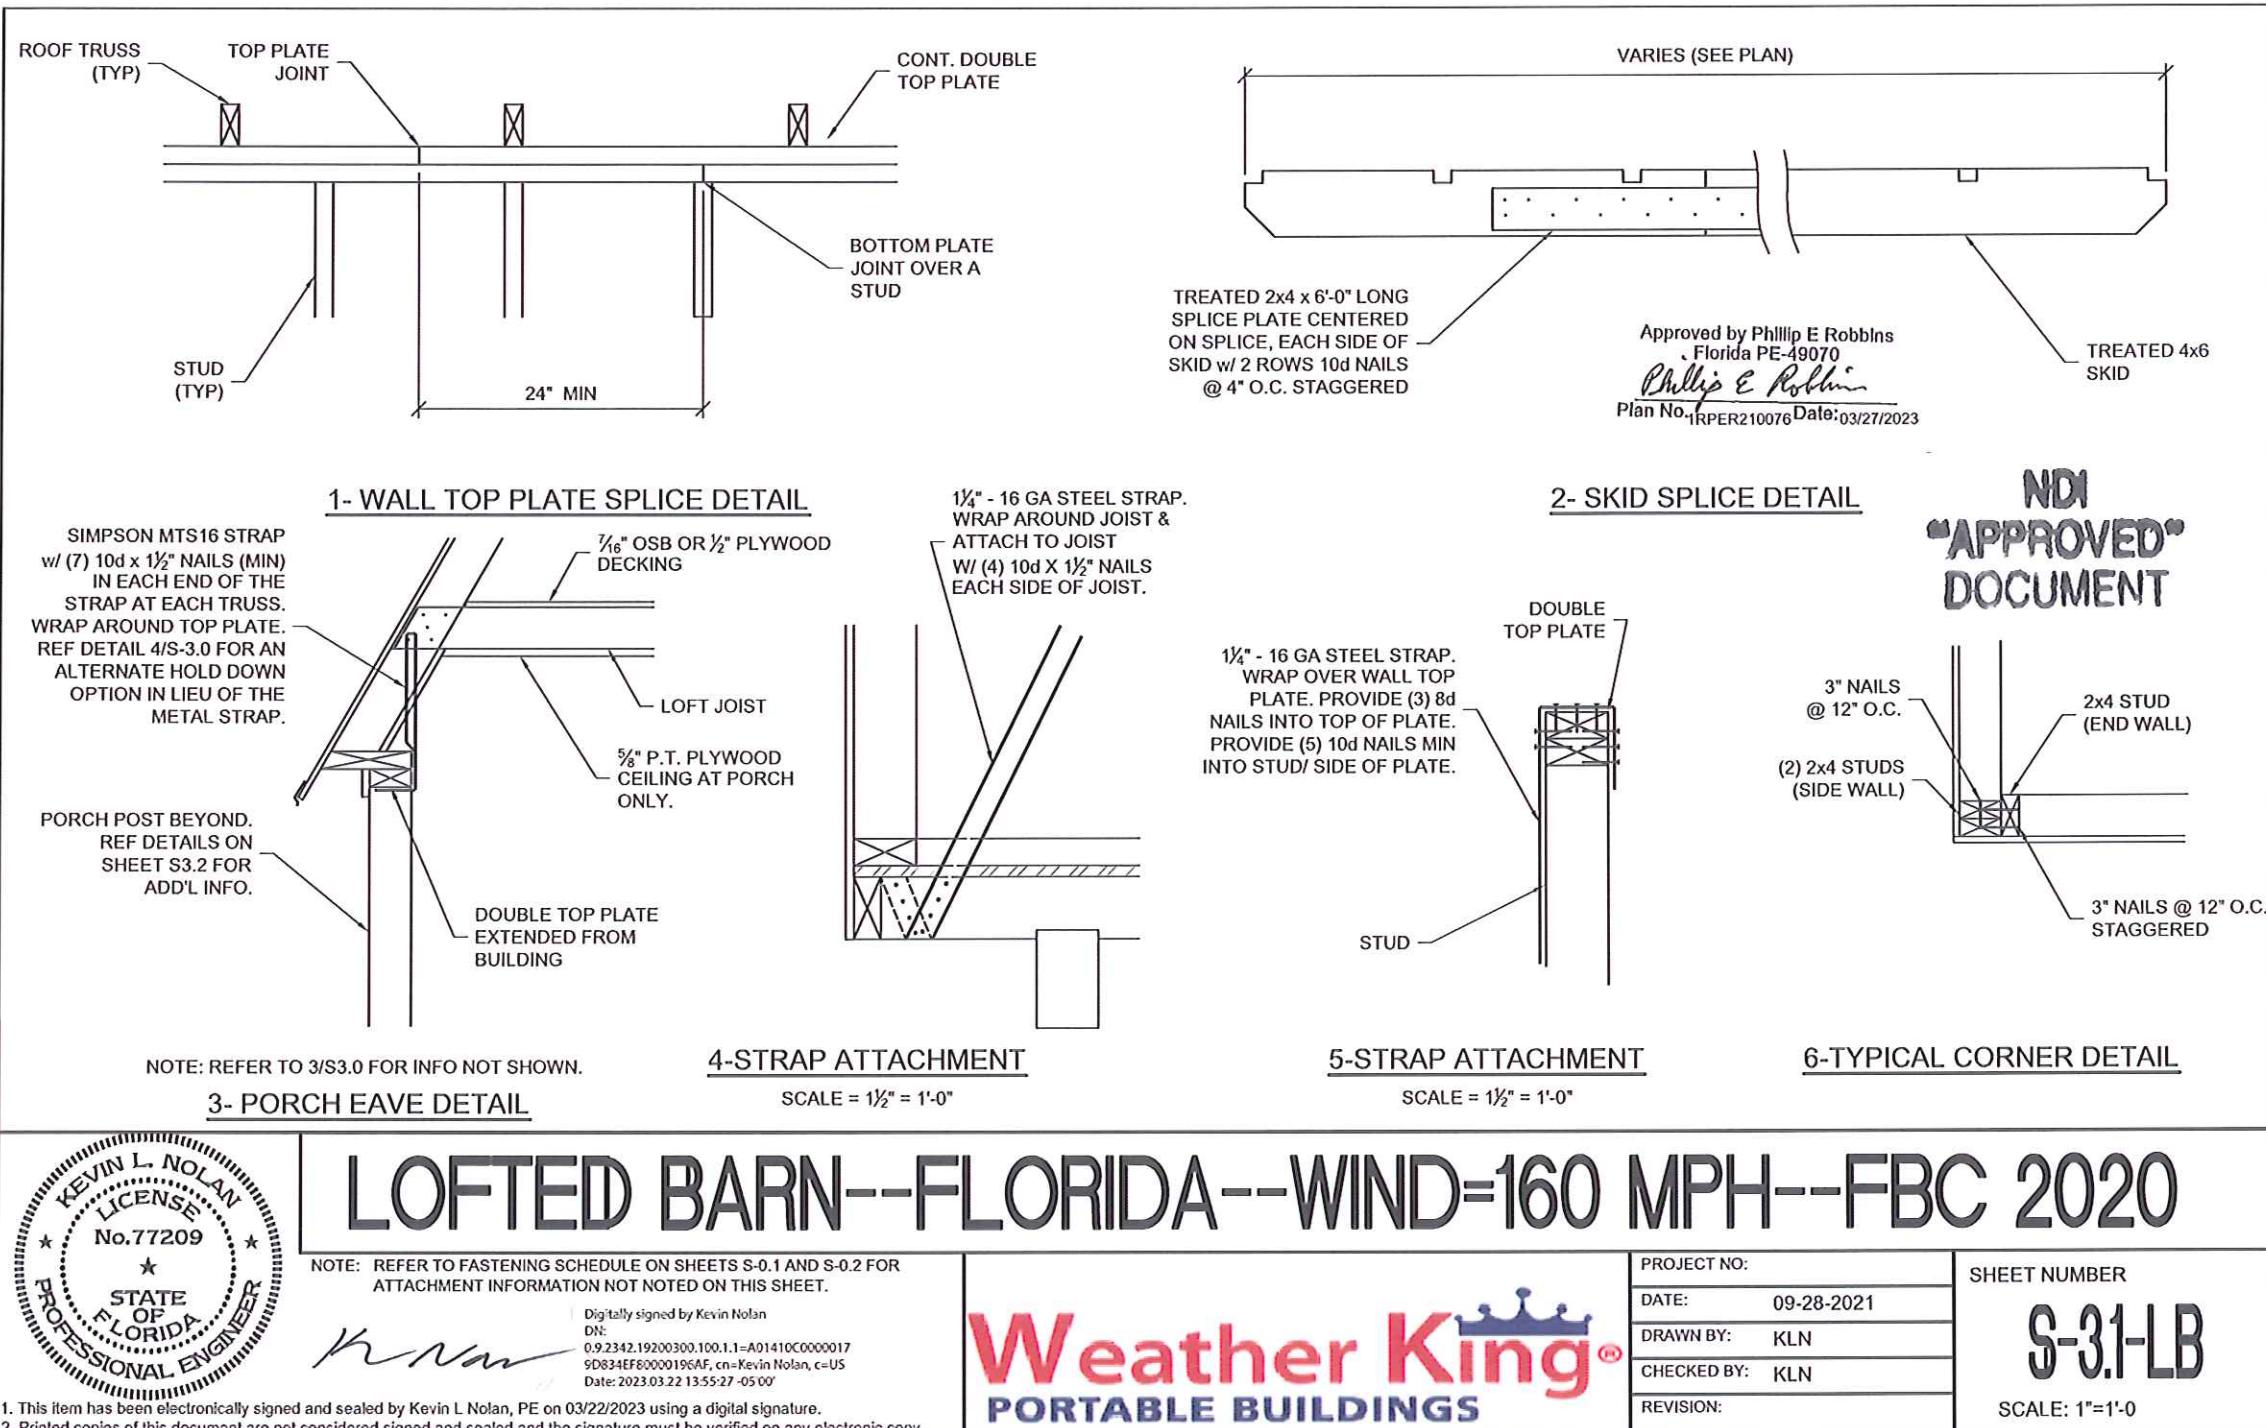

LOFTED BARN--FLORIDA--WIND=160 MPH--FBC 2020

NOTE: REFER TO FASTENING SCHEDULE ON SHEETS S-0.1 AND S-0.2 FOR ATTACHMENT INFORMATION NOT NOTED ON THIS SHEET.

Digital signed by Kevin Nolan
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DS34EF00000196AF, cn=Kevin Nolan, c=US
Date: 2023.03.22 13:57:05 -05'00'

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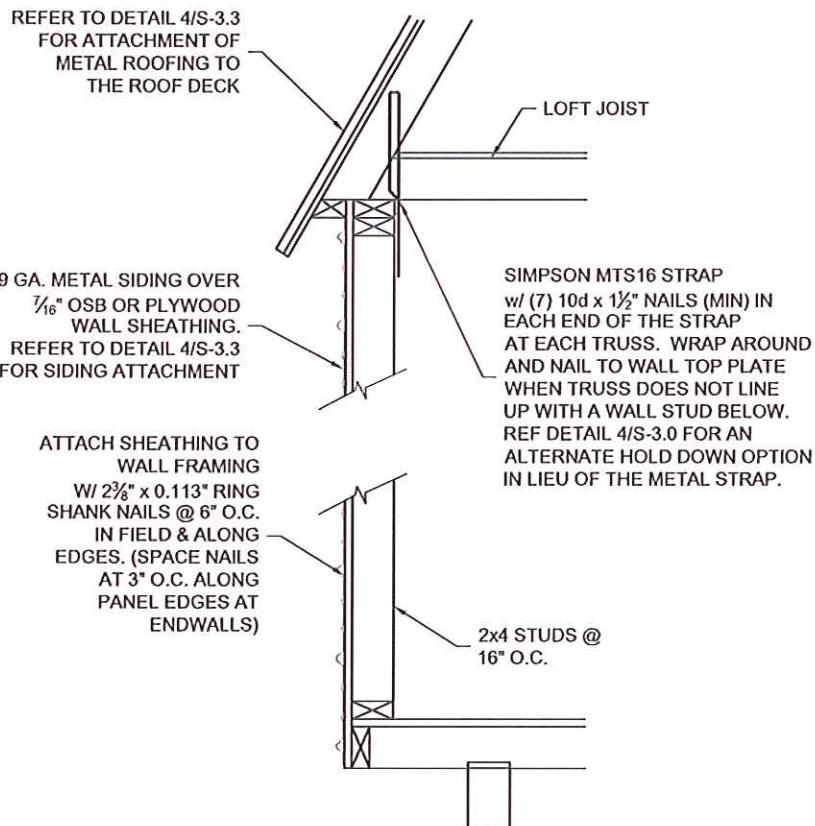
CHECKED BY: KLN

REVISION:

SHEET NUMBER

S-3.3-LB

SCALE: 1"=1'-0"



1-TYPICAL HORIZ METAL SIDING DETAIL

NOTE: REFER TO DETAILS 1/S3.0 AND 3/S3.0 FOR INFO NOT SHOWN.

Approved by Phillip E Robbins
Florida PE-49070
Phillip E Robbins
Plan No. 1RPER210076 Date: 03/27/2023

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LOFTED BARN--FLORIDA--WIND=160 MPH--FBC 2020

NOTE: REFER TO FASTENING SCHEDULE ON SHEETS S-0.1 AND S-0.2 FOR ATTACHMENT INFORMATION NOT NOTED ON THIS SHEET.

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Digitally signed by Kevin Nolan
DN: 0.9.2342.19200300.100.1.1=A01410C00009179
D034F20000196AF, cn=Kevin Nolan, c=US
Date: 2023.03.22 13:58:01 -05'00'

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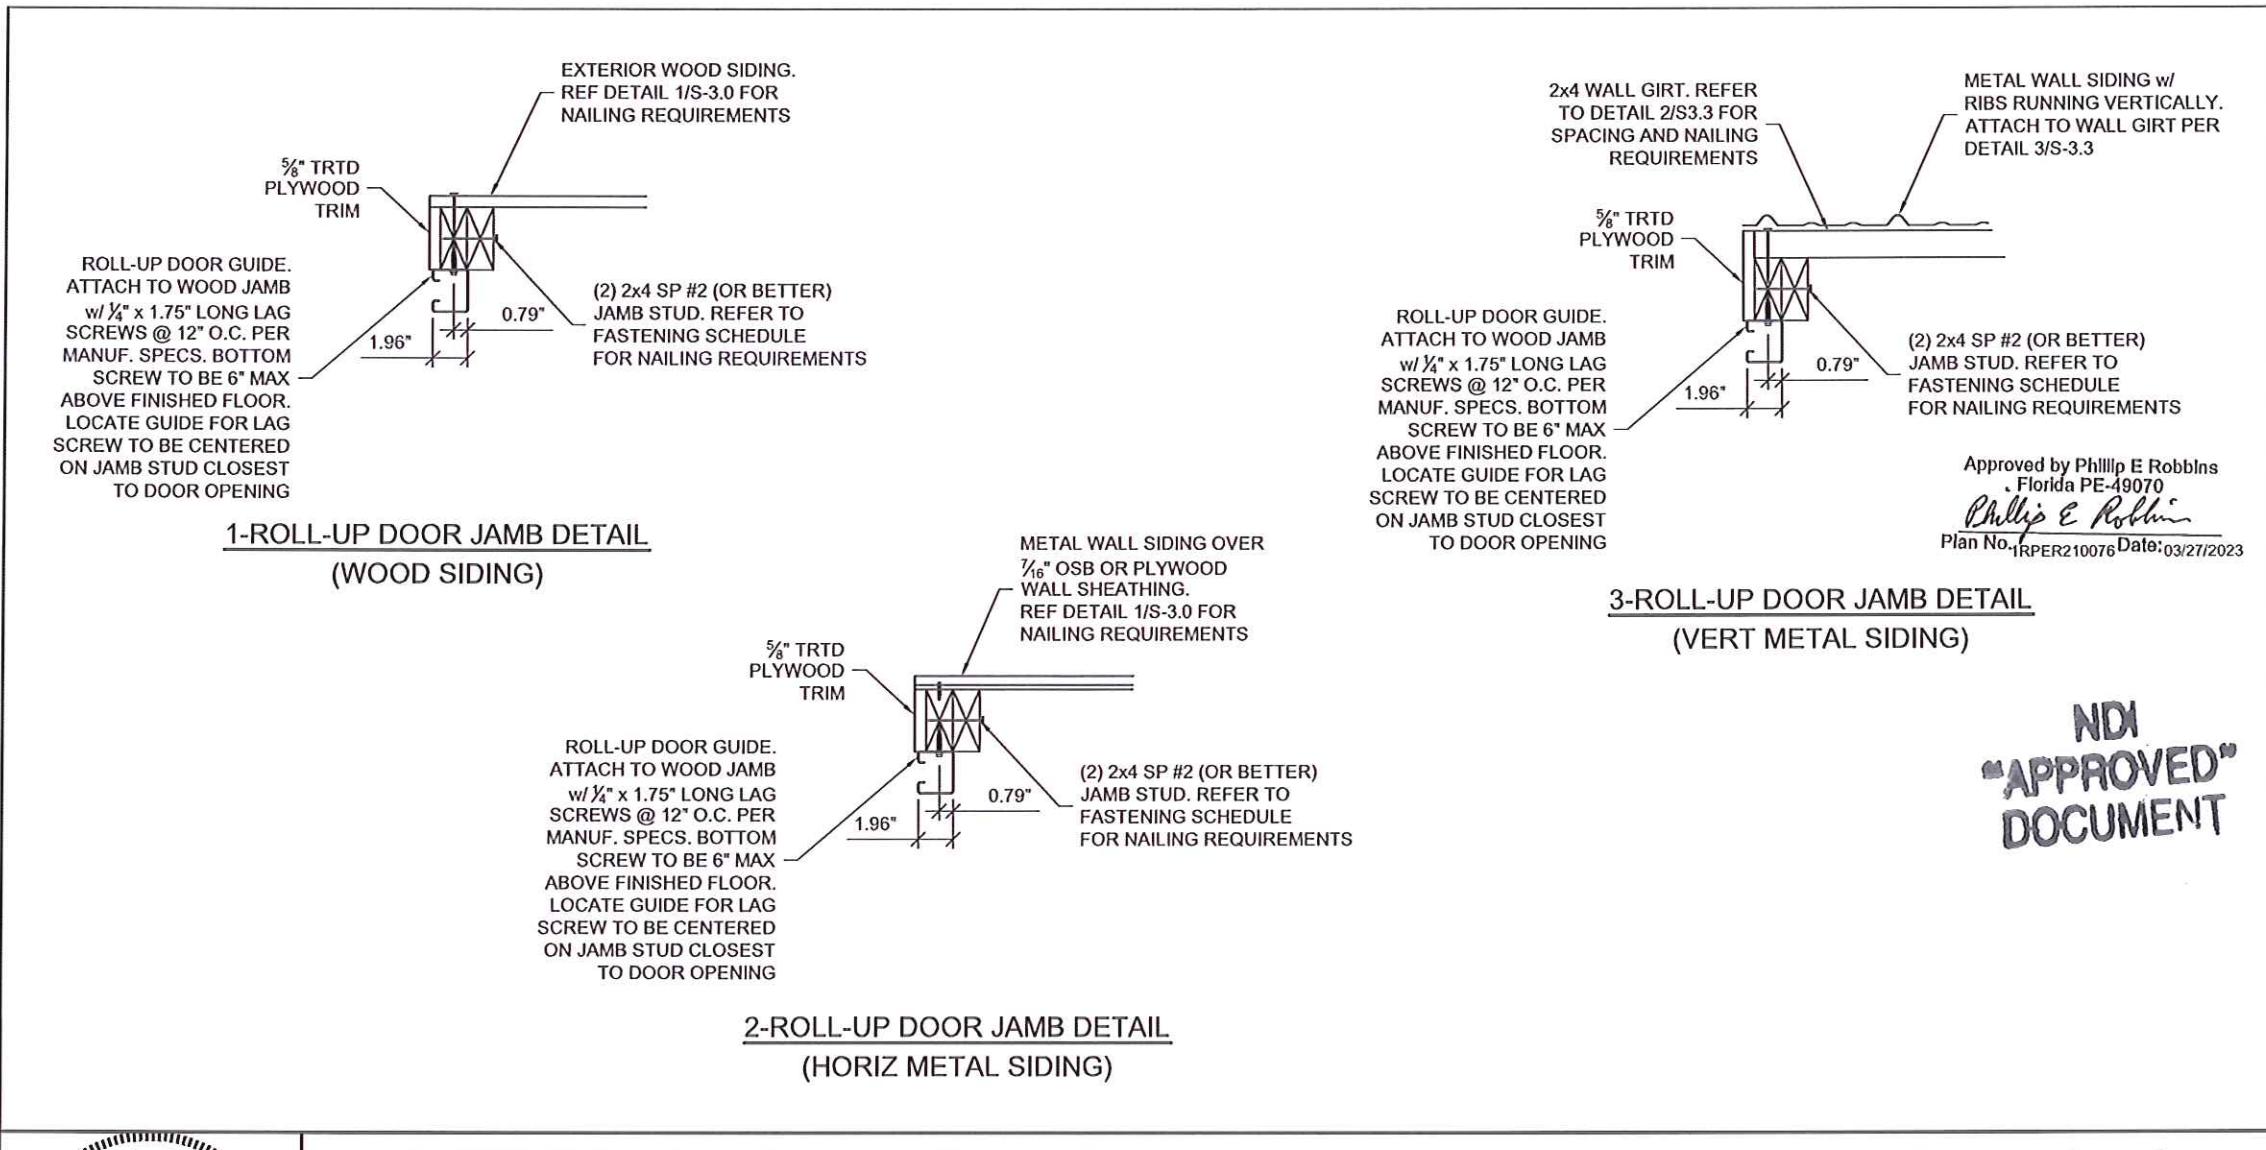
CHECKED BY: KLN

REVISION:

SHEET NUMBER

S-34-LB

SCALE: 1"=1'-0"



LOFTED BARN--FLORIDA--WIND=160 MPH--FBC 2020

NOTE: REFER TO FASTENING SCHEDULE ON SHEETS S-0.1 AND S-0.2 FOR ATTACHMENT INFORMATION NOT NOTED ON THIS SHEET.

Digitally signed by Kevin Nolan
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Date: 2023.03.22 13:58:47 -05'00'

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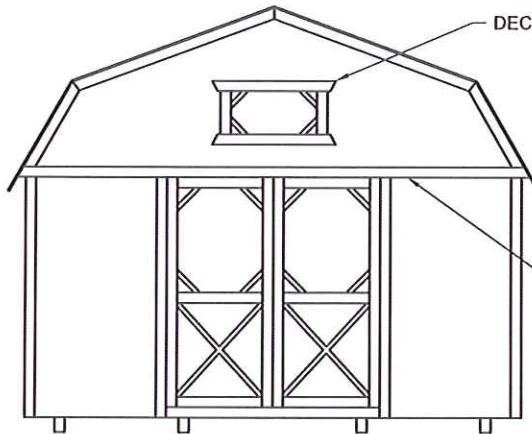
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REVISION:

SHEET NUMBER


S-3.5-LB

SCALE: 1 1/2"=1'-0




FRONT ELEVATION

DECORATIVE TRIM
PROVIDE CONTINUOUS
ALUMINUM Z-BAR FLASHING
AT SIDING HORIZONTAL JOINTS.
ATTACH TO FRAMING w/ 1"x $\frac{3}{4}$ "
STAPLES AT 12" O.C. (TYP)

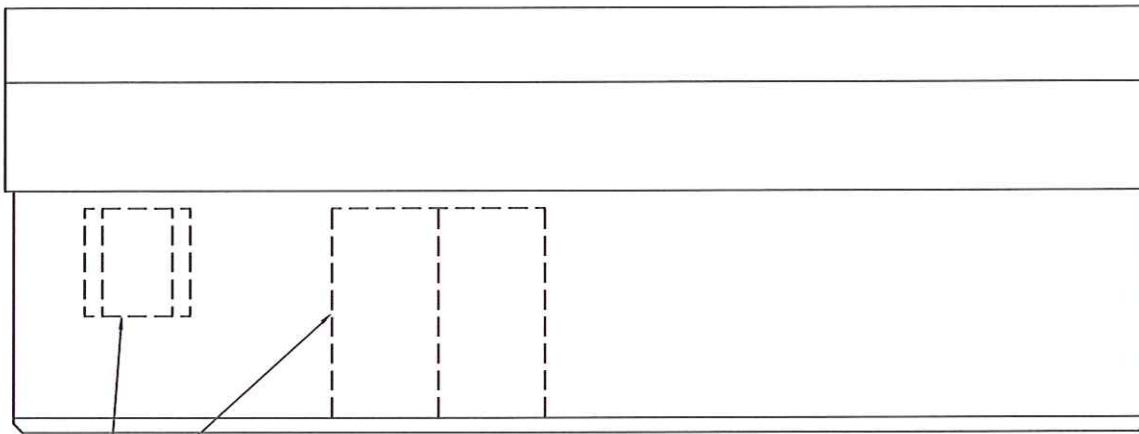

SIDE ELEVATION

DOOR AND WINDOW LOCATIONS
VARY PER CUSTOMER.

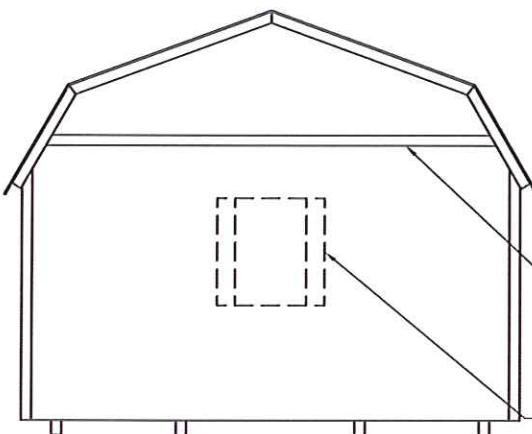

REAR ELEVATION

PROVIDE CONTINUOUS
ALUMINUM Z-BAR FLASHING
AT SIDING HORIZONTAL JOINTS.
ATTACH TO FRAMING w/ 1"x $\frac{3}{4}$ "
STAPLES AT 12" O.C. (TYP)

OPTIONAL DOOR OR WINDOW.
LOCATIONS VARY PER CUSTOMER.

NOTE:
WINDOWS, DOORS, AND TRIM SHOWN ARE CONCEPTUAL. ACTUAL WINDOW, DOOR, AND TRIM
MAY VARY PER CUSTOMER REQUEST.

Approved by Phillip E Robbins
Florida PE-49070
Phillip E Robbins
Plan No. 1RPER210076 Date: 03/27/2023

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DOCUMENT



LOFTED BARN--FLORIDA--WIND=160 MPH--FBC 2020

Digitally signed by Kevin Nolan
DN:
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000179D834EF80000196AF, cn=Kevin
Nolan, c=US
Date: 2023.03.22 14:00:02 -05'00'

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CHECKED BY: KLN

REVISION:

SHEET NUMBER

S-4-LB

SCALE: NOT TO SCALE